CIVIL PLAN SET

Residence Inn Airview Blvd

5135 PORTAGE RD. City of Kalamazoo Kalamazoo County, MI 8/13/24


OWNER

750 TRADE CENTRE WAY, SUITE 100 PORTAGE, MI 49002 (269) 342-8600

PLANS PREPARED BY:



hurley & stewart, Ilc 269.552.4960 fax 269.552.4961

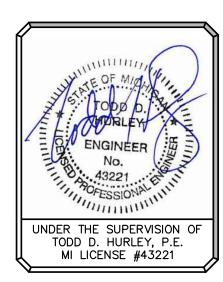

2919 MILLCORK STREET KALAMAZOO, MI 49001

PB3132@ATT.COM

(269) 384-4476, PHILIP BARDOCZ

UTILITY CONTACTS:

CHARTER COMMUNICATIONS, 4176 COMMERCIAL AVENUE PORTAGE, MI 49002 (269) 459-8746, BRIAN LONGCORE BRYAN.LONGCORE2@CHARTER.COM	CABLE	CITY OF KALAMAZOO, 415 STOCKBRIDGE AVENUE KALAMAZOO, MI 49001 (269) 337—8601, RON RIDENOUR RIDENOURR@KALAMAZOOCITY.ORG	FIBER OPTIC
COMCAST CABLE 25626 TELEGRAPH ROAD SOUTHFIELD, MI 48034 1 (734) 359-1669, JEFF DOBIES JDOBIES@COMCAST.COM	CABLE/FIBER	CTS TELECOM, 13800 EAST MICHIGAN AVENUE GALESBURG, MI 49053 (269) 746-3232, TOM CADY TCADY@CTSTELECOM.COM	TELECOM
CONSUMERS ENERGY, 2500 EAST CORK STREET KALAMAZOO, MI 49001 (269) 337—2245, ANDRE TAYLOR ANDRE.TAYLOR@CMSENERGY.COM	ELECTRIC	CITY OF KALAMAZOO, 415 STOCKBRIDGE AVENUE KALAMAZOO, MI 49001 (269) 337—8601, ANNA CRANDALL CRANDALLA@KALAMAZOOCITY.ORG	WATER
CONSUMERS ENERGY, 2500 EAST CORK STREET KALAMAZOO, MI 49001 (26) 337—2366, KYLE OAK KYLE.OAK@CMSENERGY.COM	GAS	CITY OF KALAMAZOO, 1415 NORTH HARRISON STREET KALAMAZOO, MI 49007 (269) 337-8736, RYAN STOUGHTON STOUGHTONR@KALAMAZOOCITY.ORG	SEWER

TELEPHONE/


Nottingham Ave PROJECT LOCATION ZONED Bender Rd Bender Rd **ZONED** M1 -OFFICE USE Airview Blvd **CITY OF PORTAGE** CC Kalamazoo-Buttle Creek International Airport Eckener Dr Helen Ave

DRAWING INDEX

SHT # DESCRIPTION

- C-1 EXISTING CONDITIONS & DEMO PLAN
- C-2 SITE LAYOUT PLAN
- C-3 UTILITY PLAN
- C-4 WATER MAIN PROFILES
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- C-6 SITE DETAILS
- C-7 UTILITY DETAILS
- L-1 LANDSCAPE PLAN
- L-2 LANDSCAPE DETAILS
- S-1 TOPOGRAPHIC SURVEY
- S-2 TOPOGRAPHIC SURVEY


SITE LOCATION MAP

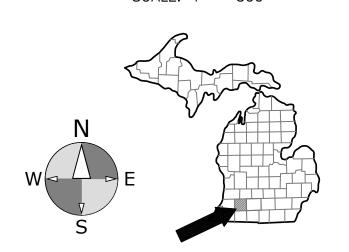



EXISTING TOPOGRAPHY PROVIDED BY HURLEY & STEWART, LLC. ALL UTILITIES AS SHOWN ARE APPROXIMATE LOCATIONS DERIVED FROM ACTUAL MEASUREMENTS AND AVAILABLE RECORDS. THEY SHOULD NOT BE INTERPRETED TO BE EXACT LOCATION NOR SHOULD IT BE ASSUMED

SITE PLAN REVIEW

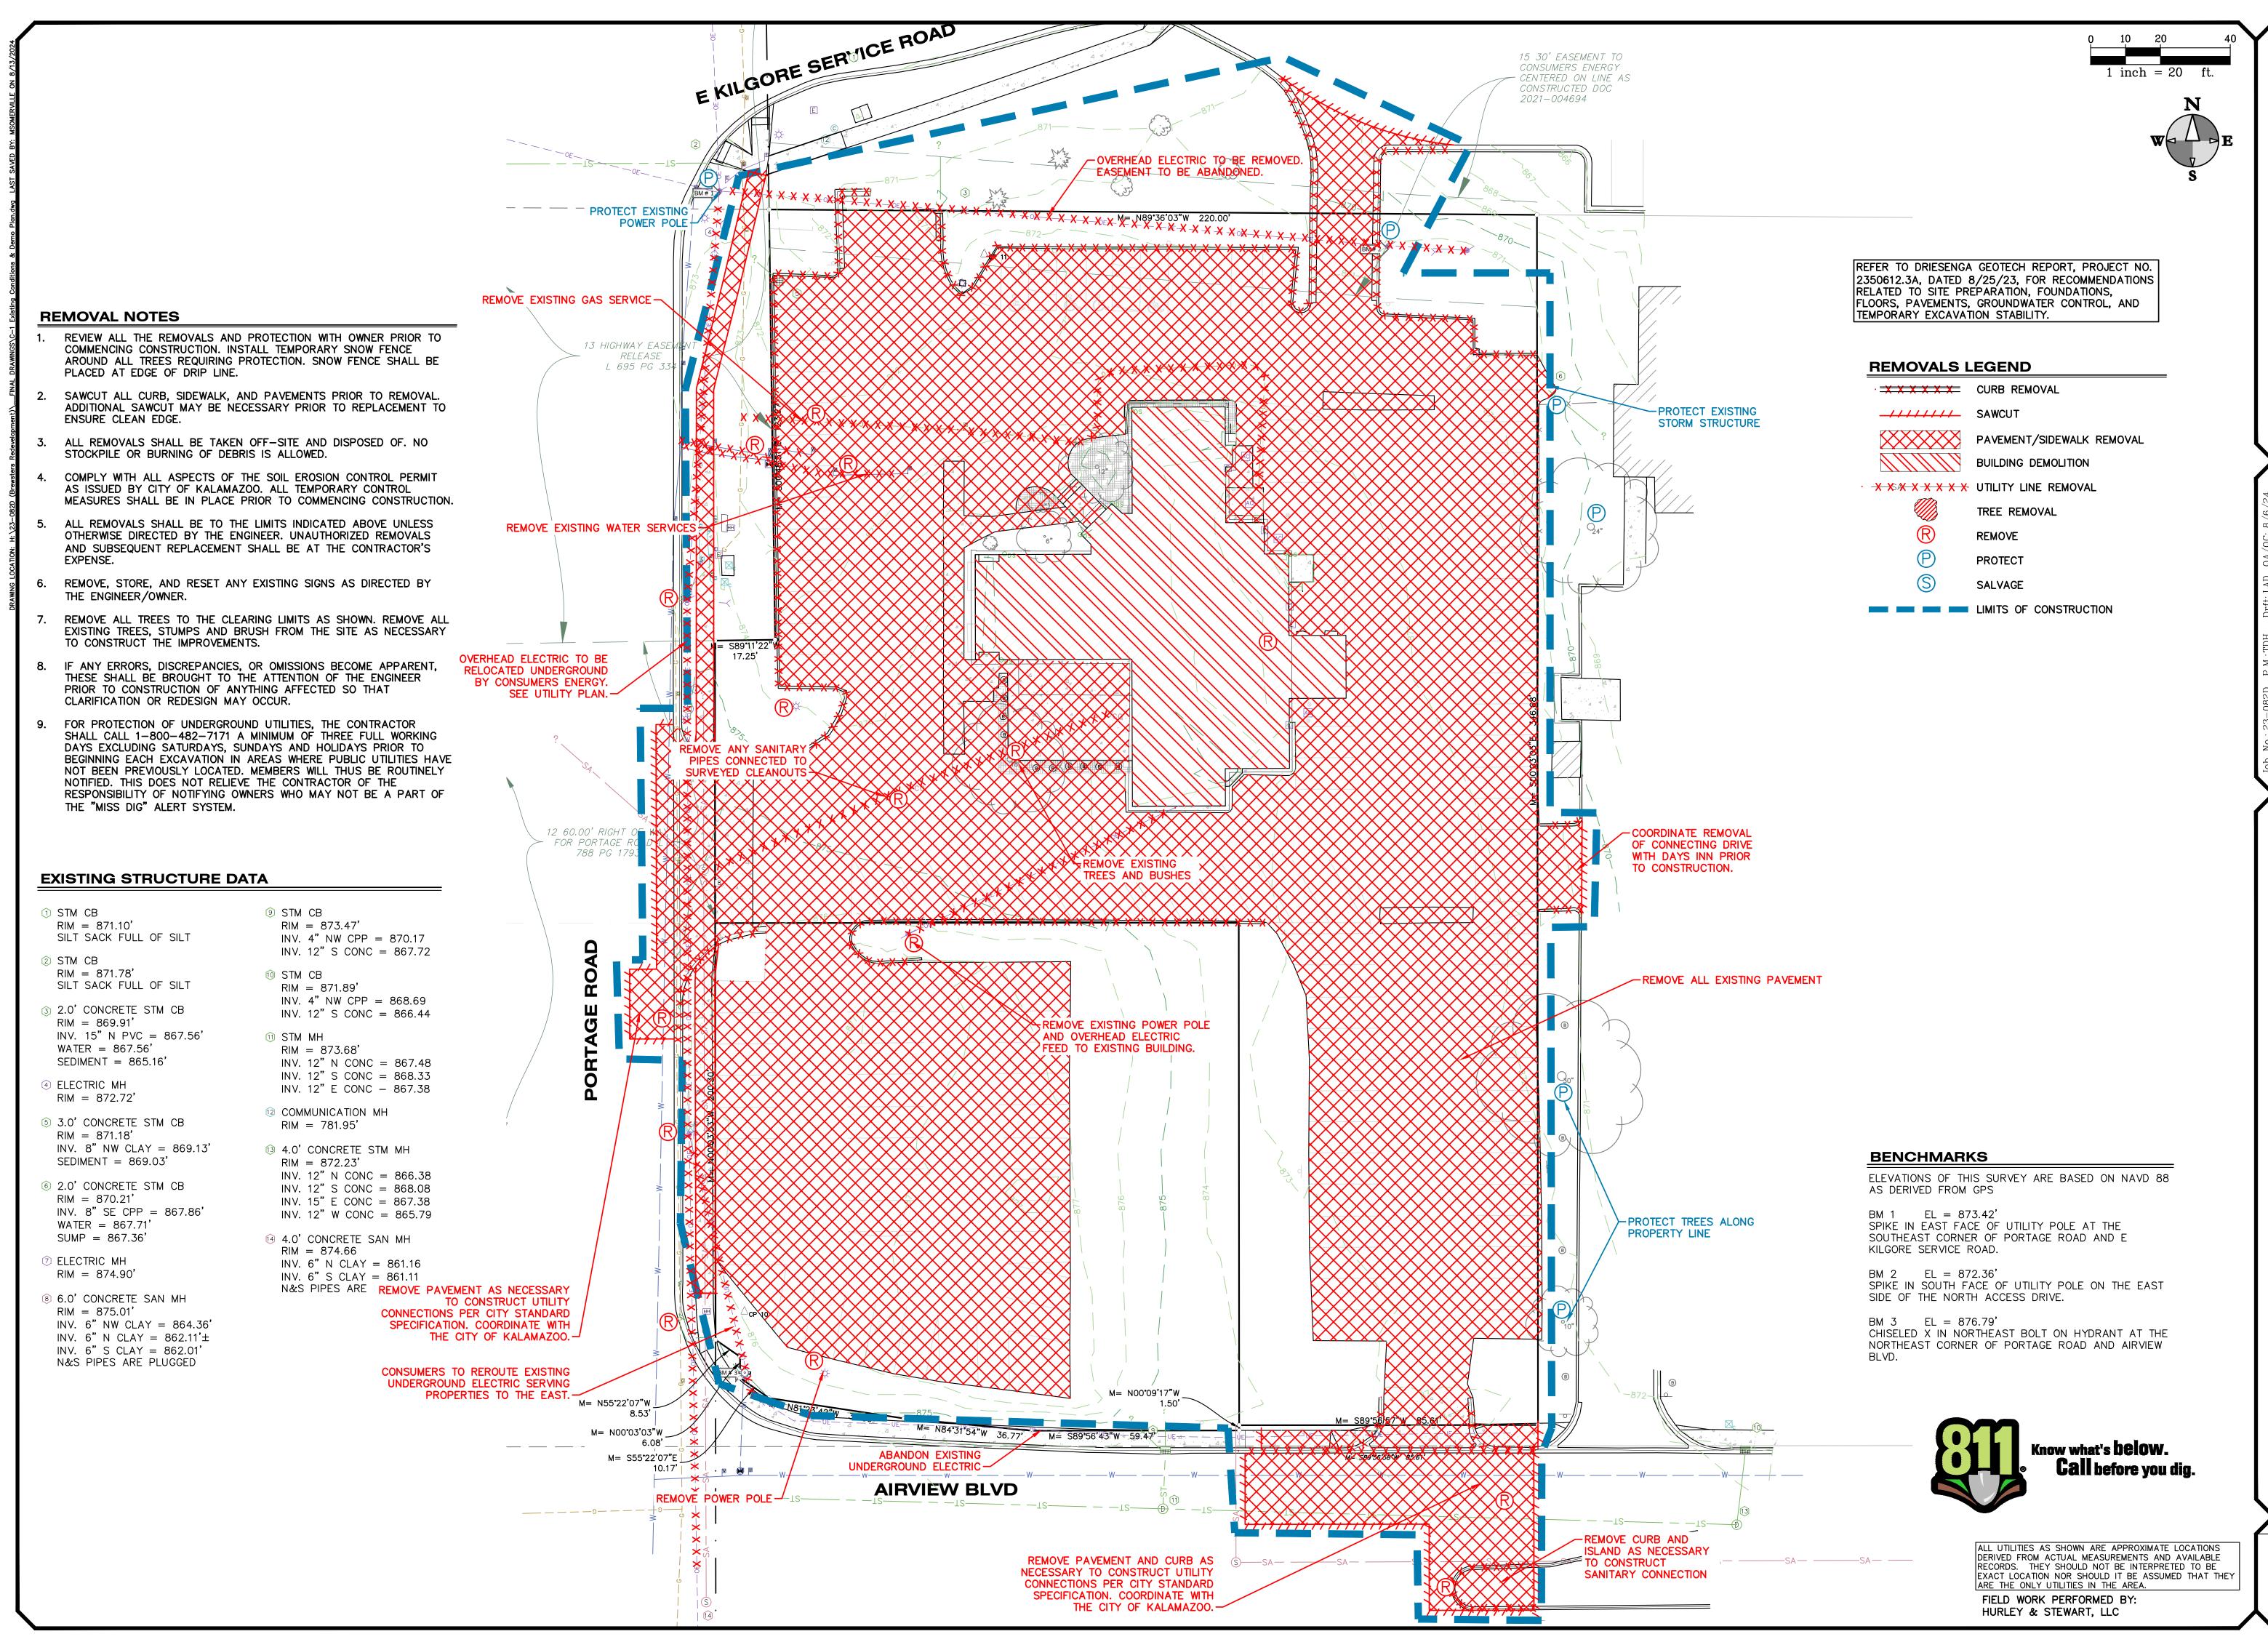

hurley & stewart, llc 2800 s. 11th street kalamazoo, michigan 49009 269.552.4960 fax 269.552.49

h 28 kg kg kg stewart w

NS: --- 3/1/24 --- 6/3/24 --- 6/3/24 --- 7/17/24 --- 8/13/24 --- 8/13/24 --- B/13/24 --- B

 Job No.: 23-082D
 P.M.: TDH
 Drft: LAD QA/QC

 ISSUED
 FOR/REVISIONS:

 2
 SITE
 PLAN
 REVIEW

 3
 ELECTRIC
 SERVICE
 REVISIONS

 4
 PRE
 APP
 REVIEW

 5
 SITE
 PLAN
 REVIEW


ING CONDITIONS & DEMO PLAN SIDENCE INN AIRVIEW BLVD

Sheet Title: Project:

8/13/24 Sheet

Sheet

C-1

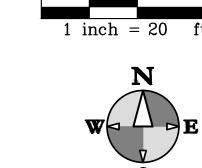

THE SITE IS ZONED CC (COMMUNITY COMMERCIAL)

- 1 SPACES PER HOTEL ROOM 98 ROOMS - 1 SPACE PER EMPLOYEE = 5 SPACES TOTAL PARKING PROVIDED = 106 SPACES ALL BARRIER FREE SPACES DESIGNED PER ADA REQUIREMENTS

TYPICAL PARKING SPACE DIMENSION = 9'X18'

- 1 SPACE PER 7 EMPLOYEE = 1 SPACE 2 LOOPS

2 REQUIRED TREES. SEE SHEET L-1 FOR LANDSCAPE PLAN

HEAVY-DUTY BITUMINOUS PAVEMENT

STANDARD-DUTY BITUMINOUS PAVEMENT

HEAVY-DUTY CONCRETE PAVEMENT

PARKING STRIPING (BLUE) PARKING STRIPING (GREEN)

PROPOSED LANDSCAPING (SEE LANDSCAPE PLAN)

M MDOT DETAIL M DRIVEWAY OPENING (SEE DETAIL)

ELEVATIONS OF THIS SURVEY ARE BASED ON NAVD 88

SOUTHEAST CORNER OF PORTAGE ROAD AND E

SPIKE IN SOUTH FACE OF UTILITY POLE ON THE EAST

CHISELED X IN NORTHEAST BOLT ON HYDRANT AT THE NORTHEAST CORNER OF PORTAGE ROAD AND AIRVIEW

> Know what's **below**. Call before you dig.

ALL UTILITIES AS SHOWN ARE APPROXIMATE LOCATIONS DERIVED FROM ACTUAL MEASUREMENTS AND AVAILABLE RECORDS. THEY SHOULD NOT BE INTERPRETED TO BE EXACT LOCATION NOR SHOULD IT BE ASSUMED THAT THEY ARE THE ONLY UTILITIES IN THE AREA.

FIELD WORK PERFORMED BY: HURLEY & STEWART, LLC

 Sheet


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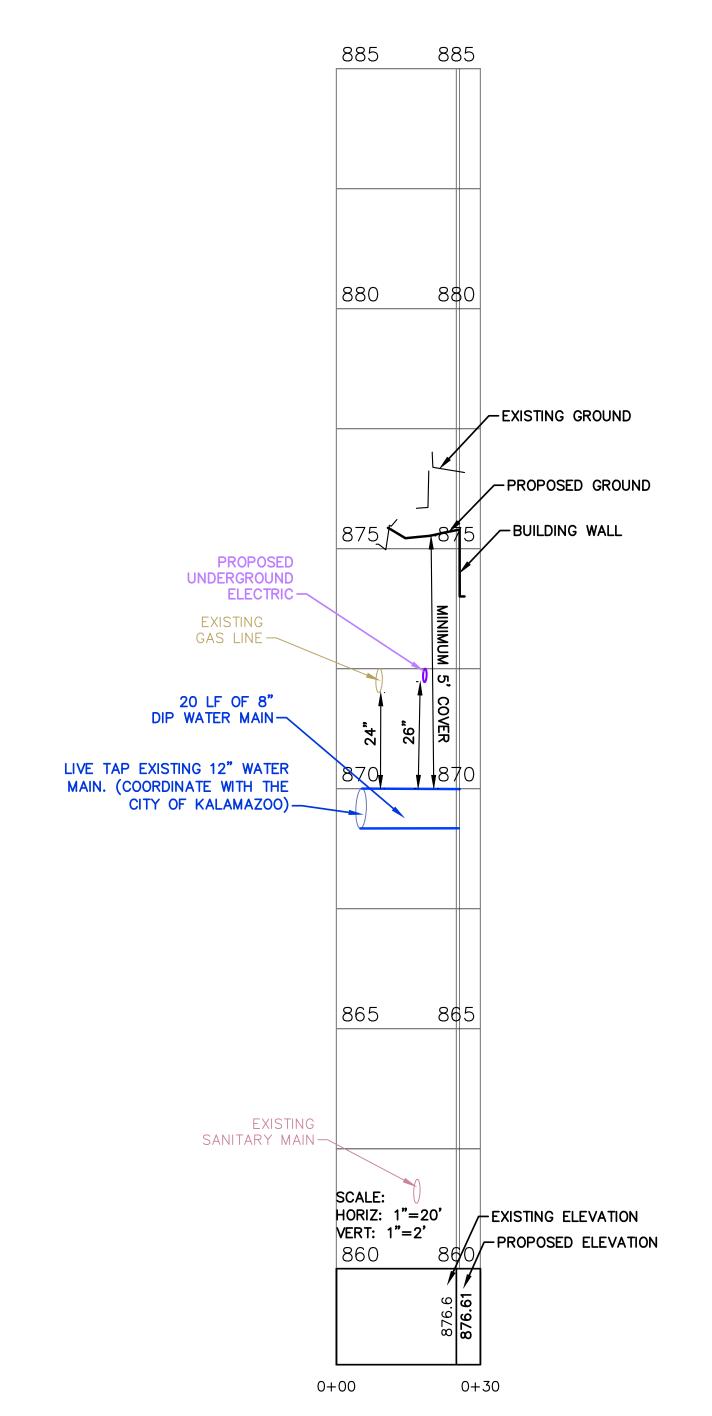
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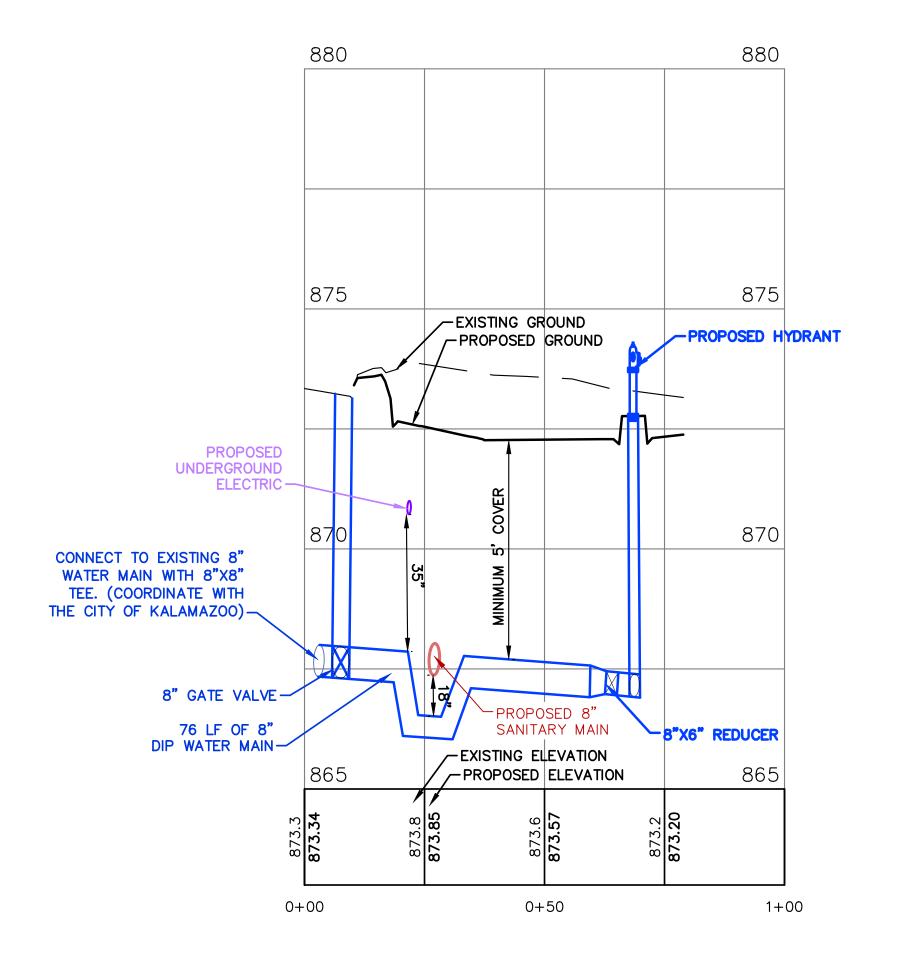
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PORTAGE ROAD WATER MAIN CONNECTION



AIRVIEW BOULEVARD WATER MAIN CONNECTION





SOIL EROSION AND SEDIMENTATION CONTROL MEASURES

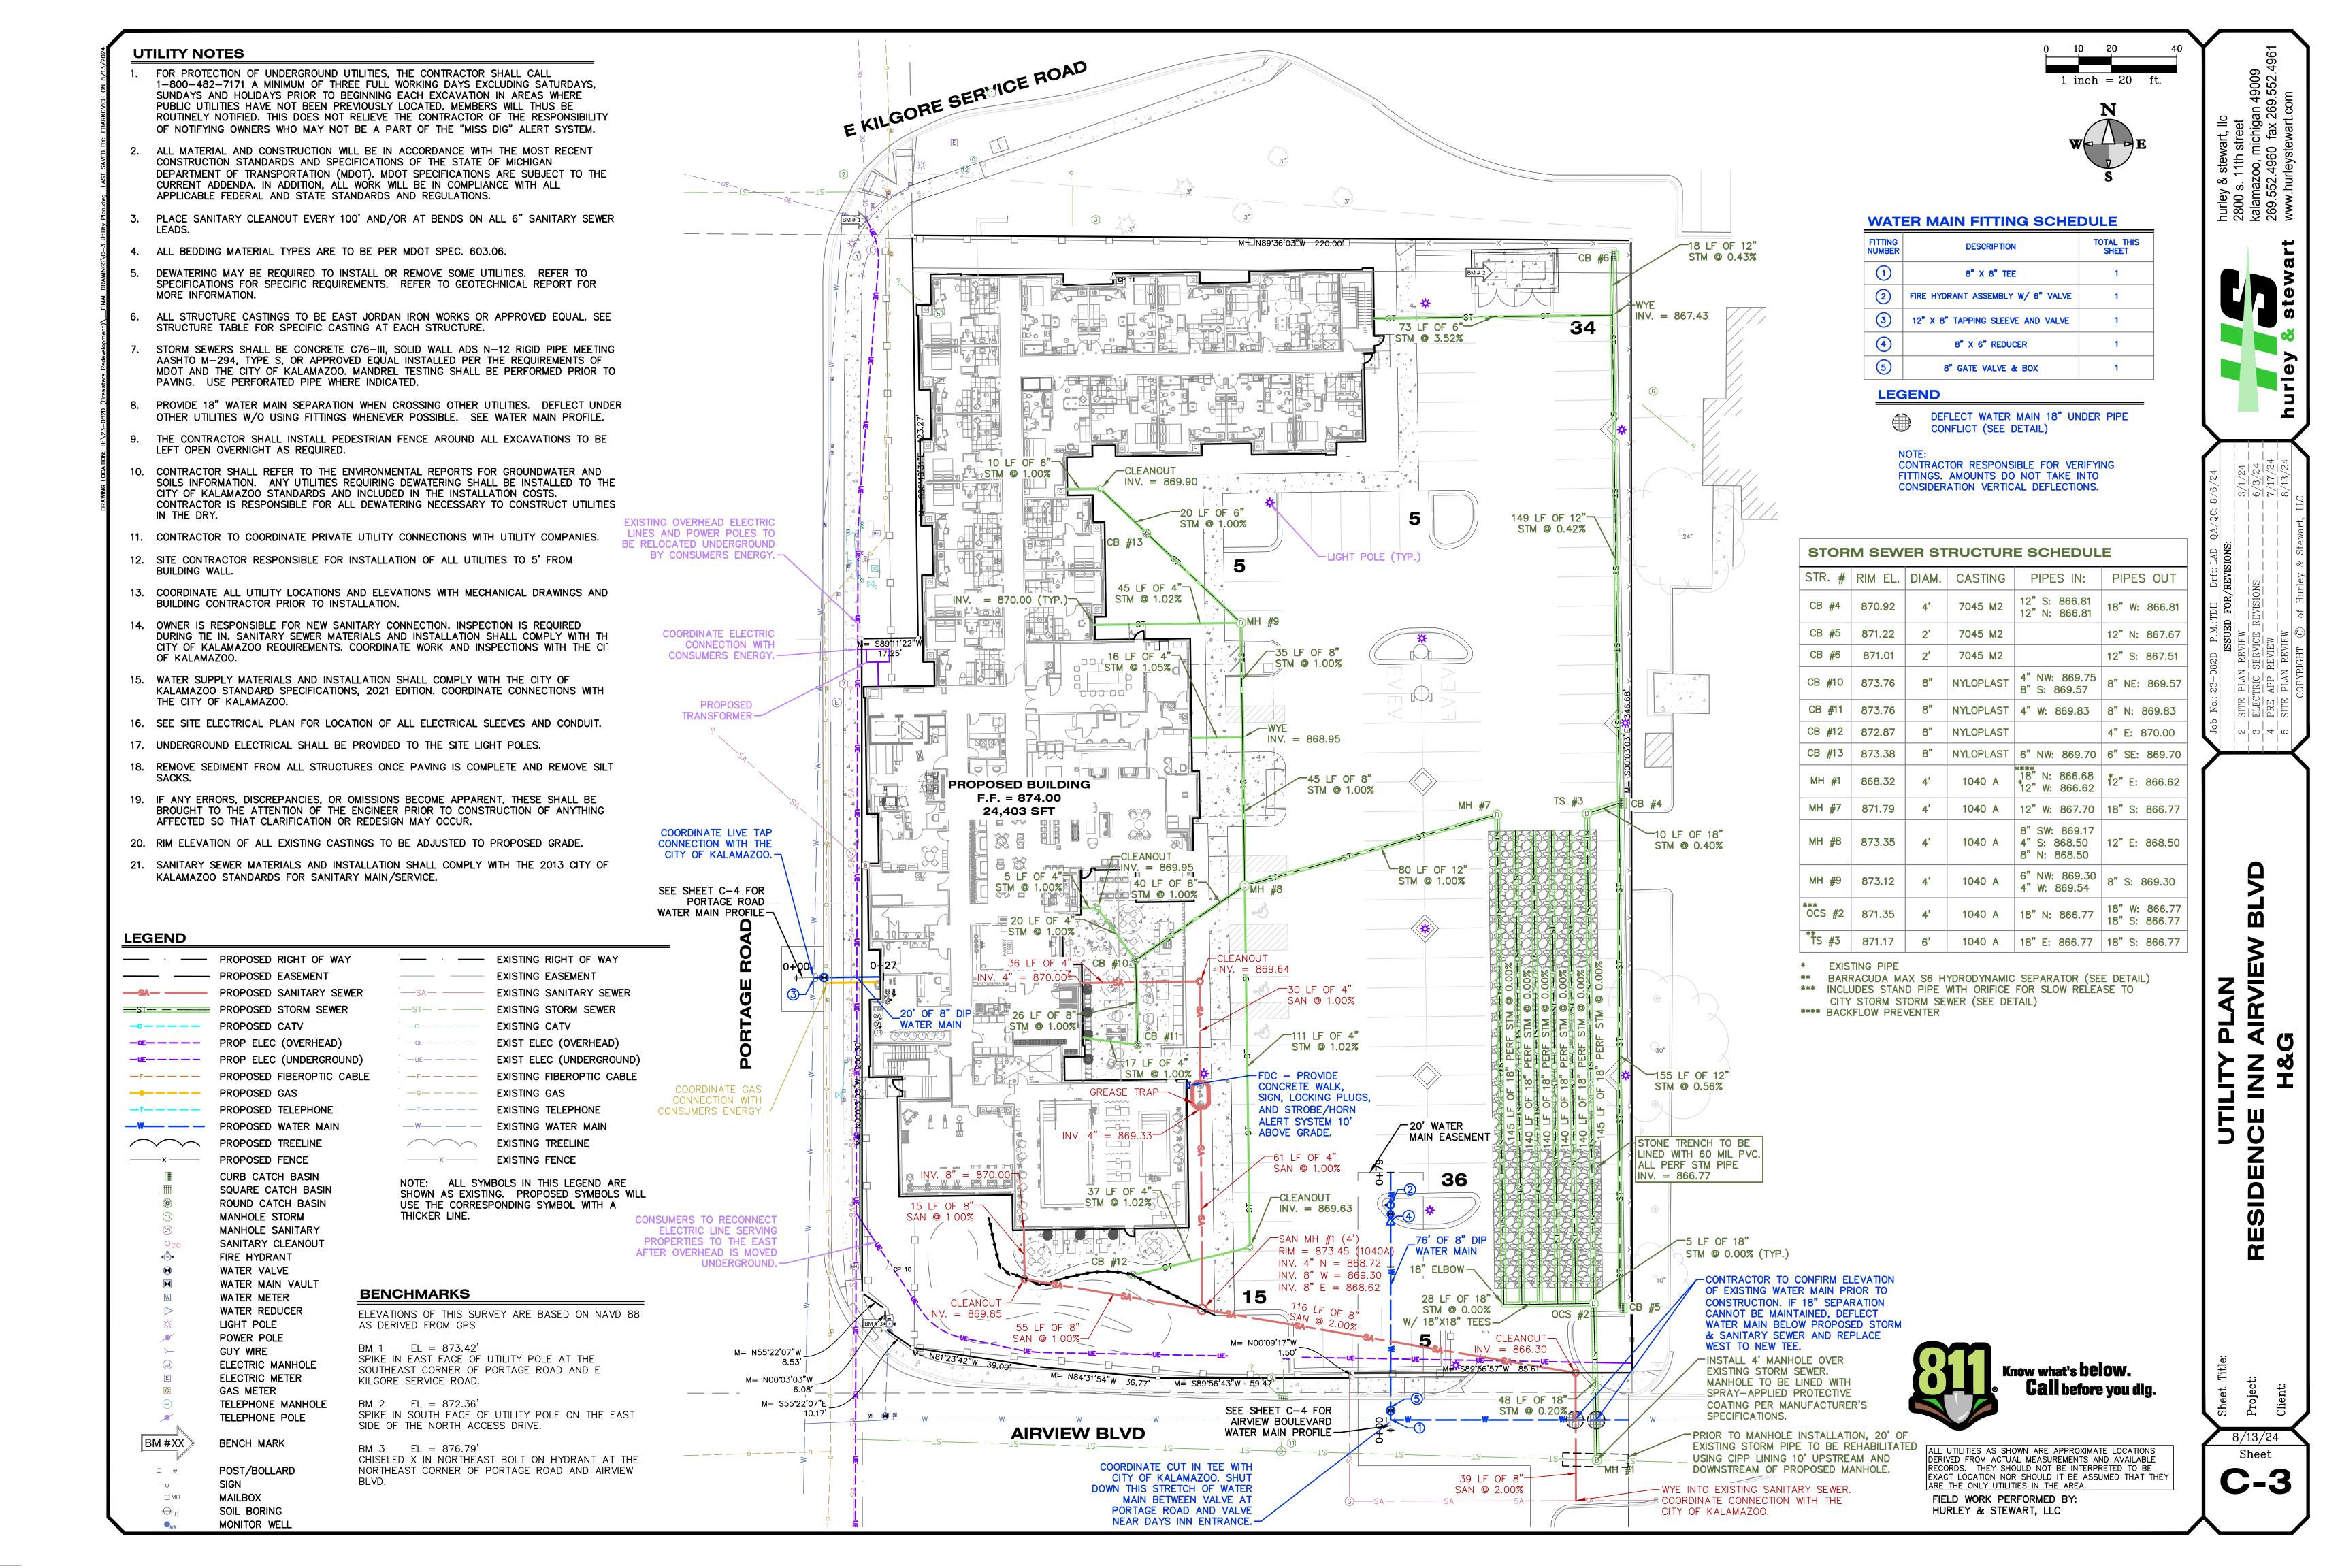
KEY	BEST MANAGEMENT PRACTICES	SYMBOL	WHERE USED
E8	PERMANENT SEEDING	ANT TO THE WAY OF THE	Stabilization method utilized on sites where earth change has been completed (final grading attained).
E9	MULCH BLANKETS		On exposed slopes, newly seeded areas, new ditch bottoms, or areas subject to erosion.
S51	SILT FENCE		Use adjacent to critical areas, to prevent sediment laden sheet flow from entering these areas.
S53	STABILIZED CONSTRUCTION ACCESS		Used at every point where construction traffic enters or leaves a construction site.
S58	INLET PROTECTION FABRIC DROP		Use at stormwater inlets, especially at construction sites.


GRADING & SESC NOTES

- ALL WORK WILL COMPLY WITH THE PROVISIONS OF THE SOIL EROSION AND SEDIMENTATION CONTROL ACT (PA 451, PART 91 OF 1994 AS AMENDED) ADMINISTERED BY CITY OF KALAMAZOO.
- FOR INSTALLATION SPECIFICATIONS FOR SOIL EROSION AND SEDIMENTATION CONTROL (SESC) MEASURES, REFER TO THE STATE OF MICHIGAN DEPARTMENT OF TECHNOLOGY. MANAGEMENT, AND BUDGET (DTMB) SESC MANUAL.
- ALL TEMPORARY SOIL EROSION PROTECTION SHALL REMAIN IN PLACE UNTIL REMOVAL IS REQUIRED FOR FINAL CLEANUP AND APPROVAL.
- ALL SOIL EROSION CONTROL MEASURES SHALL BE IN PLACE PRIOR TO COMMENCING
- ALL SOIL PILES SHALL BE SURROUNDED BY SILT FENCE IF ALLOWED TO REMAIN IN PLACE FOR MORE THAN 7 DAYS. TOPSOIL PILES SHALL BE SEEDED IF ALLOWED TO REMAIN IN PLACE FOR MORE THAN 20 DAYS. SPOIL PILES SHALL NOT BE PLACED WITHIN 50' FROM ANY TEMPORARY OR PERMANENT WATERCOURSE.
- THE CONTRACTOR SHALL COMPLY WITH THE WEEKLY RECOMMENDATIONS OF THE CERTIFIED STORM WATER OPERATOR.
- PROVIDE SILT SACKS IN EACH CATCH BASIN UNTIL SITE IS STABILIZED.
- SEE LANDSCAPING PLAN FOR FINAL SLOPE TREATMENTS.
- PLACE TOPSOIL AND SEED ACCORDING TO THE LANDSCAPE PLANS AS SOON AS AREAS ARE BROUGHT TO GRADE.
- 10. WATER SITE WHEN NECESSARY TO PREVENT AIR BORNE SEDIMENT TRANSFER.
- THE CONTRACTOR SHALL INSTALL PEDESTRIAN FENCE AROUND ALL EXCAVATIONS TO BE LEFT OPEN OVERNIGHT AS REQUIRED.
- 12. ALL SPOT ELEVATIONS ARE TOP OF PAVEMENT GRADES AT EDGE OF METAL (EOM) UNLESS OTHERWISE NOTED.
- 13. ALL EXISTING ELEVATIONS ARE TO BE VERIFIED AND ACCEPTED AS SHOWN PRIOR TO COMMENCEMENT OF WORK.
- 14. REMOVE AND REPLACE WITH CONTROLLED FILL ANY AREAS THAT HAVE BEEN SOFTENED BY RAINS, FREEZING, CONSTRUCTION EQUIPMENT, ETC.
- 15. ALL REQUIRED FILL FOR THIS PROJECT SHALL BE SELECTED EXCAVATED MATERIAL FROM THE SITE APPROVED BY THE ENGINEER OR CLASS II GRANULAR MATERIAL FROM BORROW AND SHALL BE THE CONTRACTOR'S RESPONSIBILITY.
- 16. ALL GRANULAR FILL UNDER THE INFLUENCE OF THE ROADWAY AND PROCESSED ROAD GRAVEL SHALL BE COMPACTED TO 95% MODIFIED PROCTOR DENSITY.
- 17. ALL COMPACTION SHALL BE ACCOMPLISHED BY PLACING THE FILL IN 12" LOOSE LIFTS AND MECHANICALLY COMPACTING EACH LIFT TO AT LEAST THE SPECIFIED MINIMUM DRY DENSITY. FIELD DENSITY TESTS SHOULD BE PERFORMED ON EACH LIFT AS NECESSARY TO ENSURE THAT ADEQUATE MOISTURE CONDITIONS AND COMPACTION ARE BEING ACHIEVED.
- 18. SITE CONTRACTOR SHALL REMOVE AND STOCKPILE ALL TOPSOIL AND BLACK ORGANIC SOILS ON-SITE TO BE USED IN THE REGRADING OF LANDSCAPE AREAS. THIS MATERIAL IS NOT TO BE USED FOR FILL OR PAVEMENT SUBBASE. REMOVAL OF ANY EXCESS SOIL OFF-SITE SHALL BE THE CONTRACTOR'S RESPONSIBILITY.
- 19. CONTRACTOR RESPONSIBLE FOR VERIFYING EARTHWORK CALCULATIONS PRIOR TO COMMENCING WORK. NO EXTRA EARTHWORK WILL BE PAID FOR ONCE EARTHWORK HAS BEGUN. ANY DISCREPANCIES WITH THE EARTHWORK CALCULATIONS SHALL BE REVIEWED WITH THE OWNER AND ENGINEER PRIOR TO CONSTRUCTION.
- 20. CONTRACTOR SHALL TAKE PRECAUTIONS TO AVOID TRACKING SOIL ONTO ADJACENT ROADWAYS. SCRAPE ROAD AT THE END OF EACH WORKDAY AND SWEEP AT LEAST ONCE A WEEK.
- 21. ANY DISTURBED AREA THAT WILL BE LEFT UNWORKED 5 DAYS OR LONGER MUST BE SEEDED AND MULCHED OR SODDED TO ESTABLISH VEGETATION FOR TEMPORARY STABILIZATION. BASINS TO BE SEEDED AND MULCH BLANKETS APPLIED IMMEDIATELY TO PROVIDE A STABLE BASE AND AVOID EXCESSIVE EROSION.
- 22. ROAD RIGHTS-OF-WAY MUST BE STABILIZED WITH SEED AND MULCH WITHIN 5 DAYS OF COMPLETING UTILITY WORK IN THE RIGHT-OF-WAY.
- 23. ACCUMULATED SEDIMENT TO BE REMOVED FROM STORM SYSTEM UPON COMPLETION OF CONSTRUCTION. ALL TEMPORARY CONTROLS TO BE REMOVED AFTER SITE IS STABILIZED AND VEGETATION ESTABLISHED.
- 24. IF ANY ERRORS, DISCREPANCIES, OR OMISSIONS BECOME APPARENT, THESE SHALL BE BROUGHT TO THE ATTENTION OF THE ENGINEER PRIOR TO CONSTRUCTION OF ANYTHING AFFECTED SO THAT CLARIFICATION OR REDESIGN MAY OCCUR.
- 25. ONLY EROSION CONTROL BLANKETS SUCH AS NORTH AMERICAN GREEN BIONET S150BH, AND WESTERN WOOD FIBERS EXCEL SS-2 ALL NATURAL (BIODEGRADABLE JUTE/SCRIM NETTING WITH LENO WEAVE TYPE MESH), OR EQUIVALENT, ARE CONSIDERED ACCEPTABLE PRODUCTS. NET EROSION BLANKETS CONTAINING PLASTIC OR SYNTHETIC NET OR NETTING SHALL NO LONGER BE AUTHORIZED, PURCHASED, NOR APPROVED FOR USE.

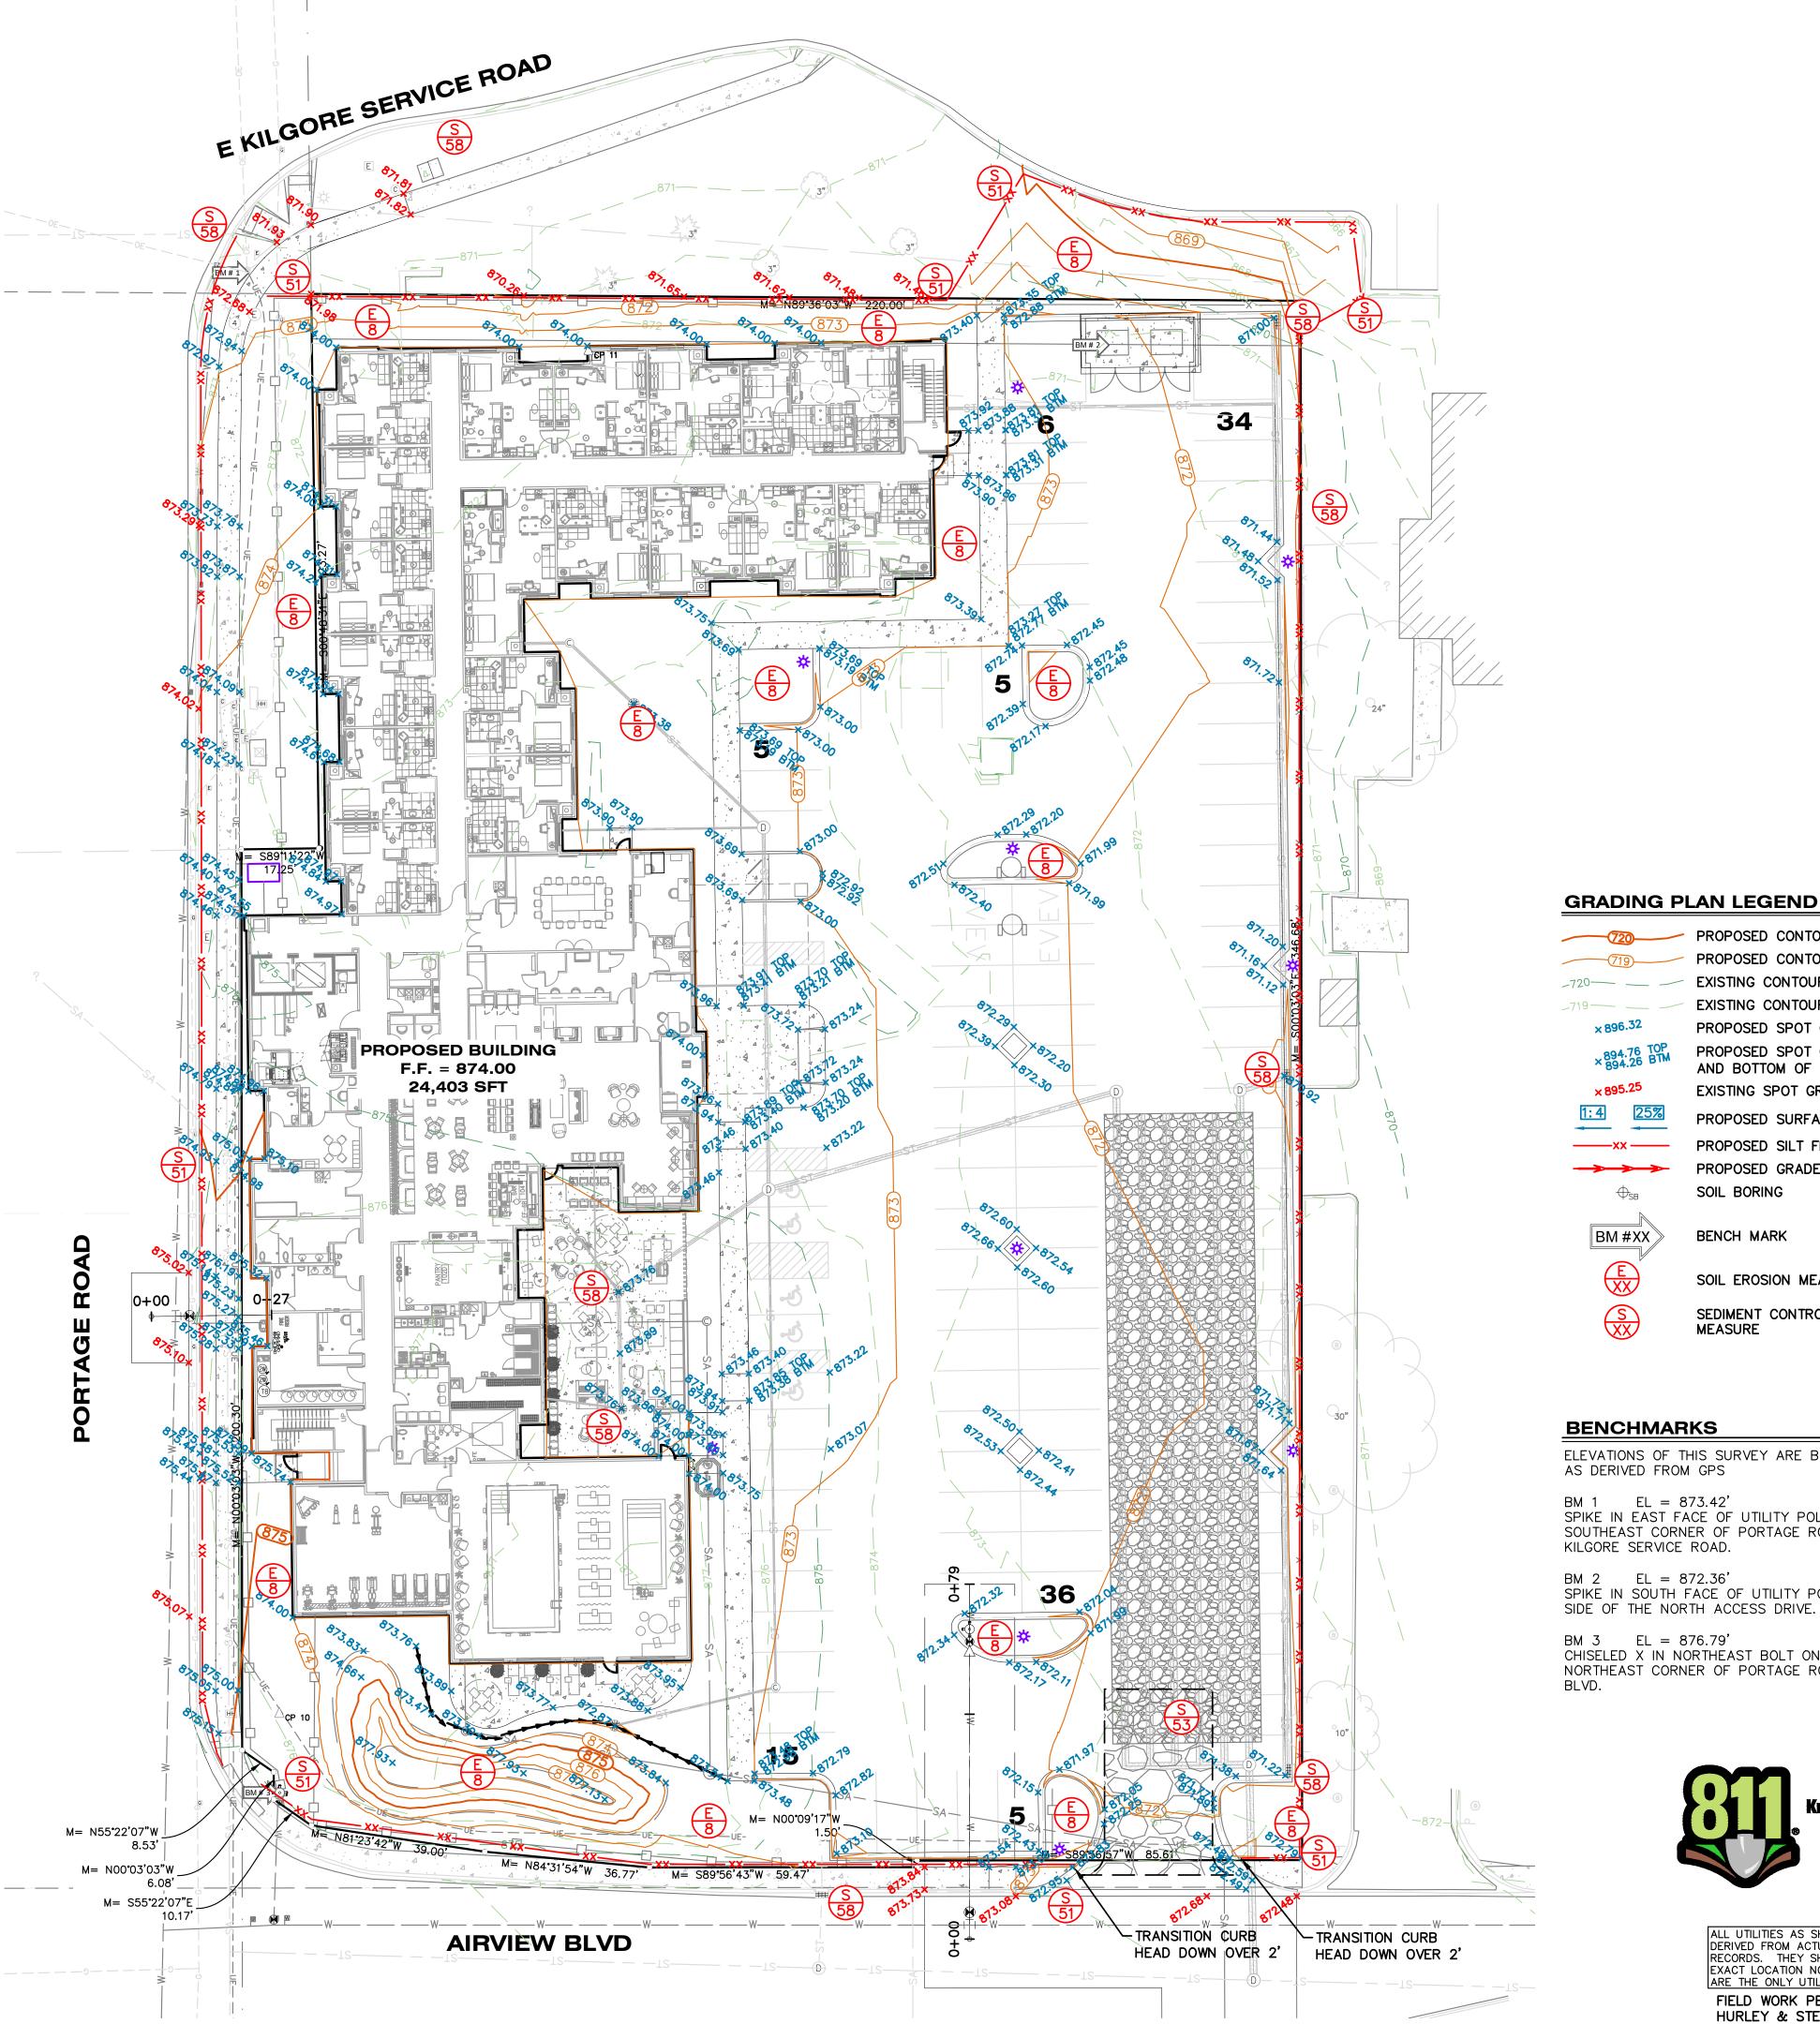

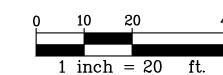

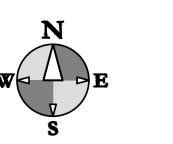

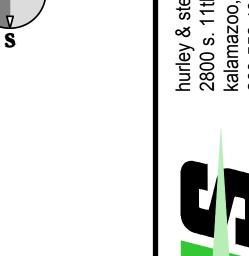

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ELEVATIONS OF THIS SURVEY ARE BASED ON NAVD 88

SPIKE IN EAST FACE OF UTILITY POLE AT THE SOUTHEAST CORNER OF PORTAGE ROAD AND E KILGORE SERVICE ROAD.

BM 2 EL = 872.36SPIKE IN SOUTH FACE OF UTILITY POLE ON THE EAST SIDE OF THE NORTH ACCESS DRIVE.

PROPOSED CONTOUR 5-FT

EXISTING CONTOUR 5-FT

PROPOSED SPOT GRADE

EXISTING SPOT GRADE

PROPOSED SILT FENCE

SOIL BORING

BENCH MARK

MEASURE

EXISTING CONTOUR NORMAL

PROPOSED CONTOUR NORMAL

PROPOSED SPOT GRADES: TOP

AND BOTTOM OF CURB/WALL

PROPOSED SURFACE SLOPE

PROPOSED GRADED SWALE

SOIL EROSION MEASURE

SEDIMENT CONTROL

BM 3 EL = 876.79CHISELED X IN NORTHEAST BOLT ON HYDRANT AT THE NORTHEAST CORNER OF PORTAGE ROAD AND AIRVIEW




FIELD WORK PERFORMED BY: HURLEY & STEWART, LLC

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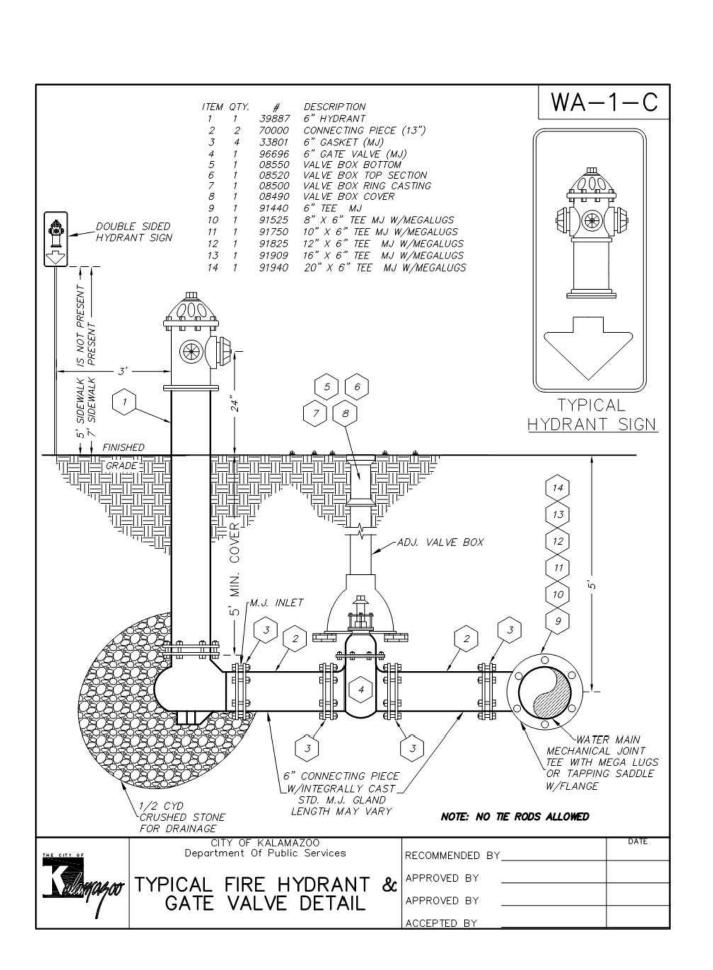
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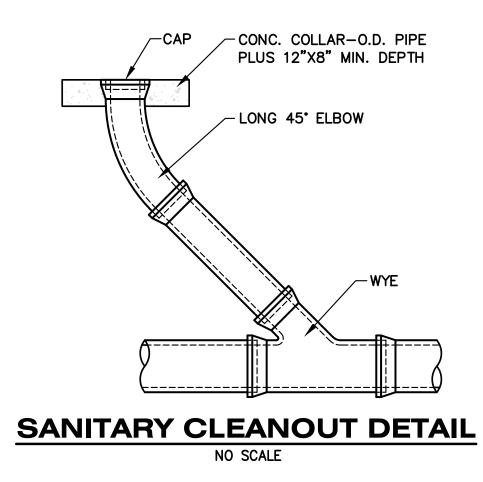
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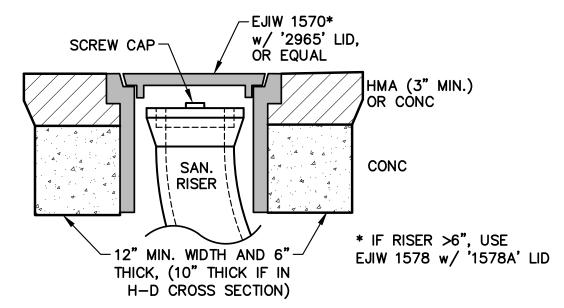
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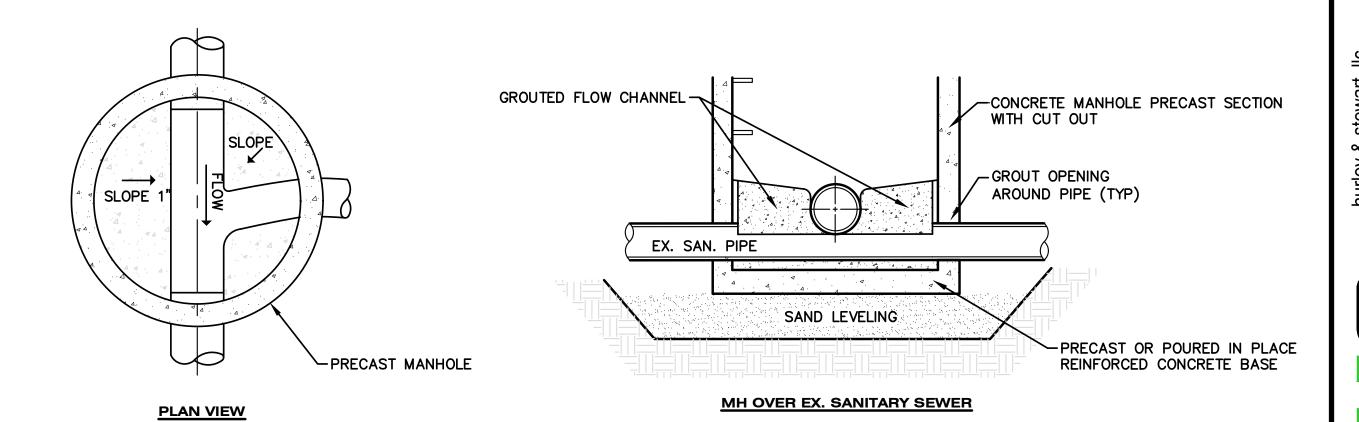
WATER MAIN DEFLECTION DETAIL NO SCALE






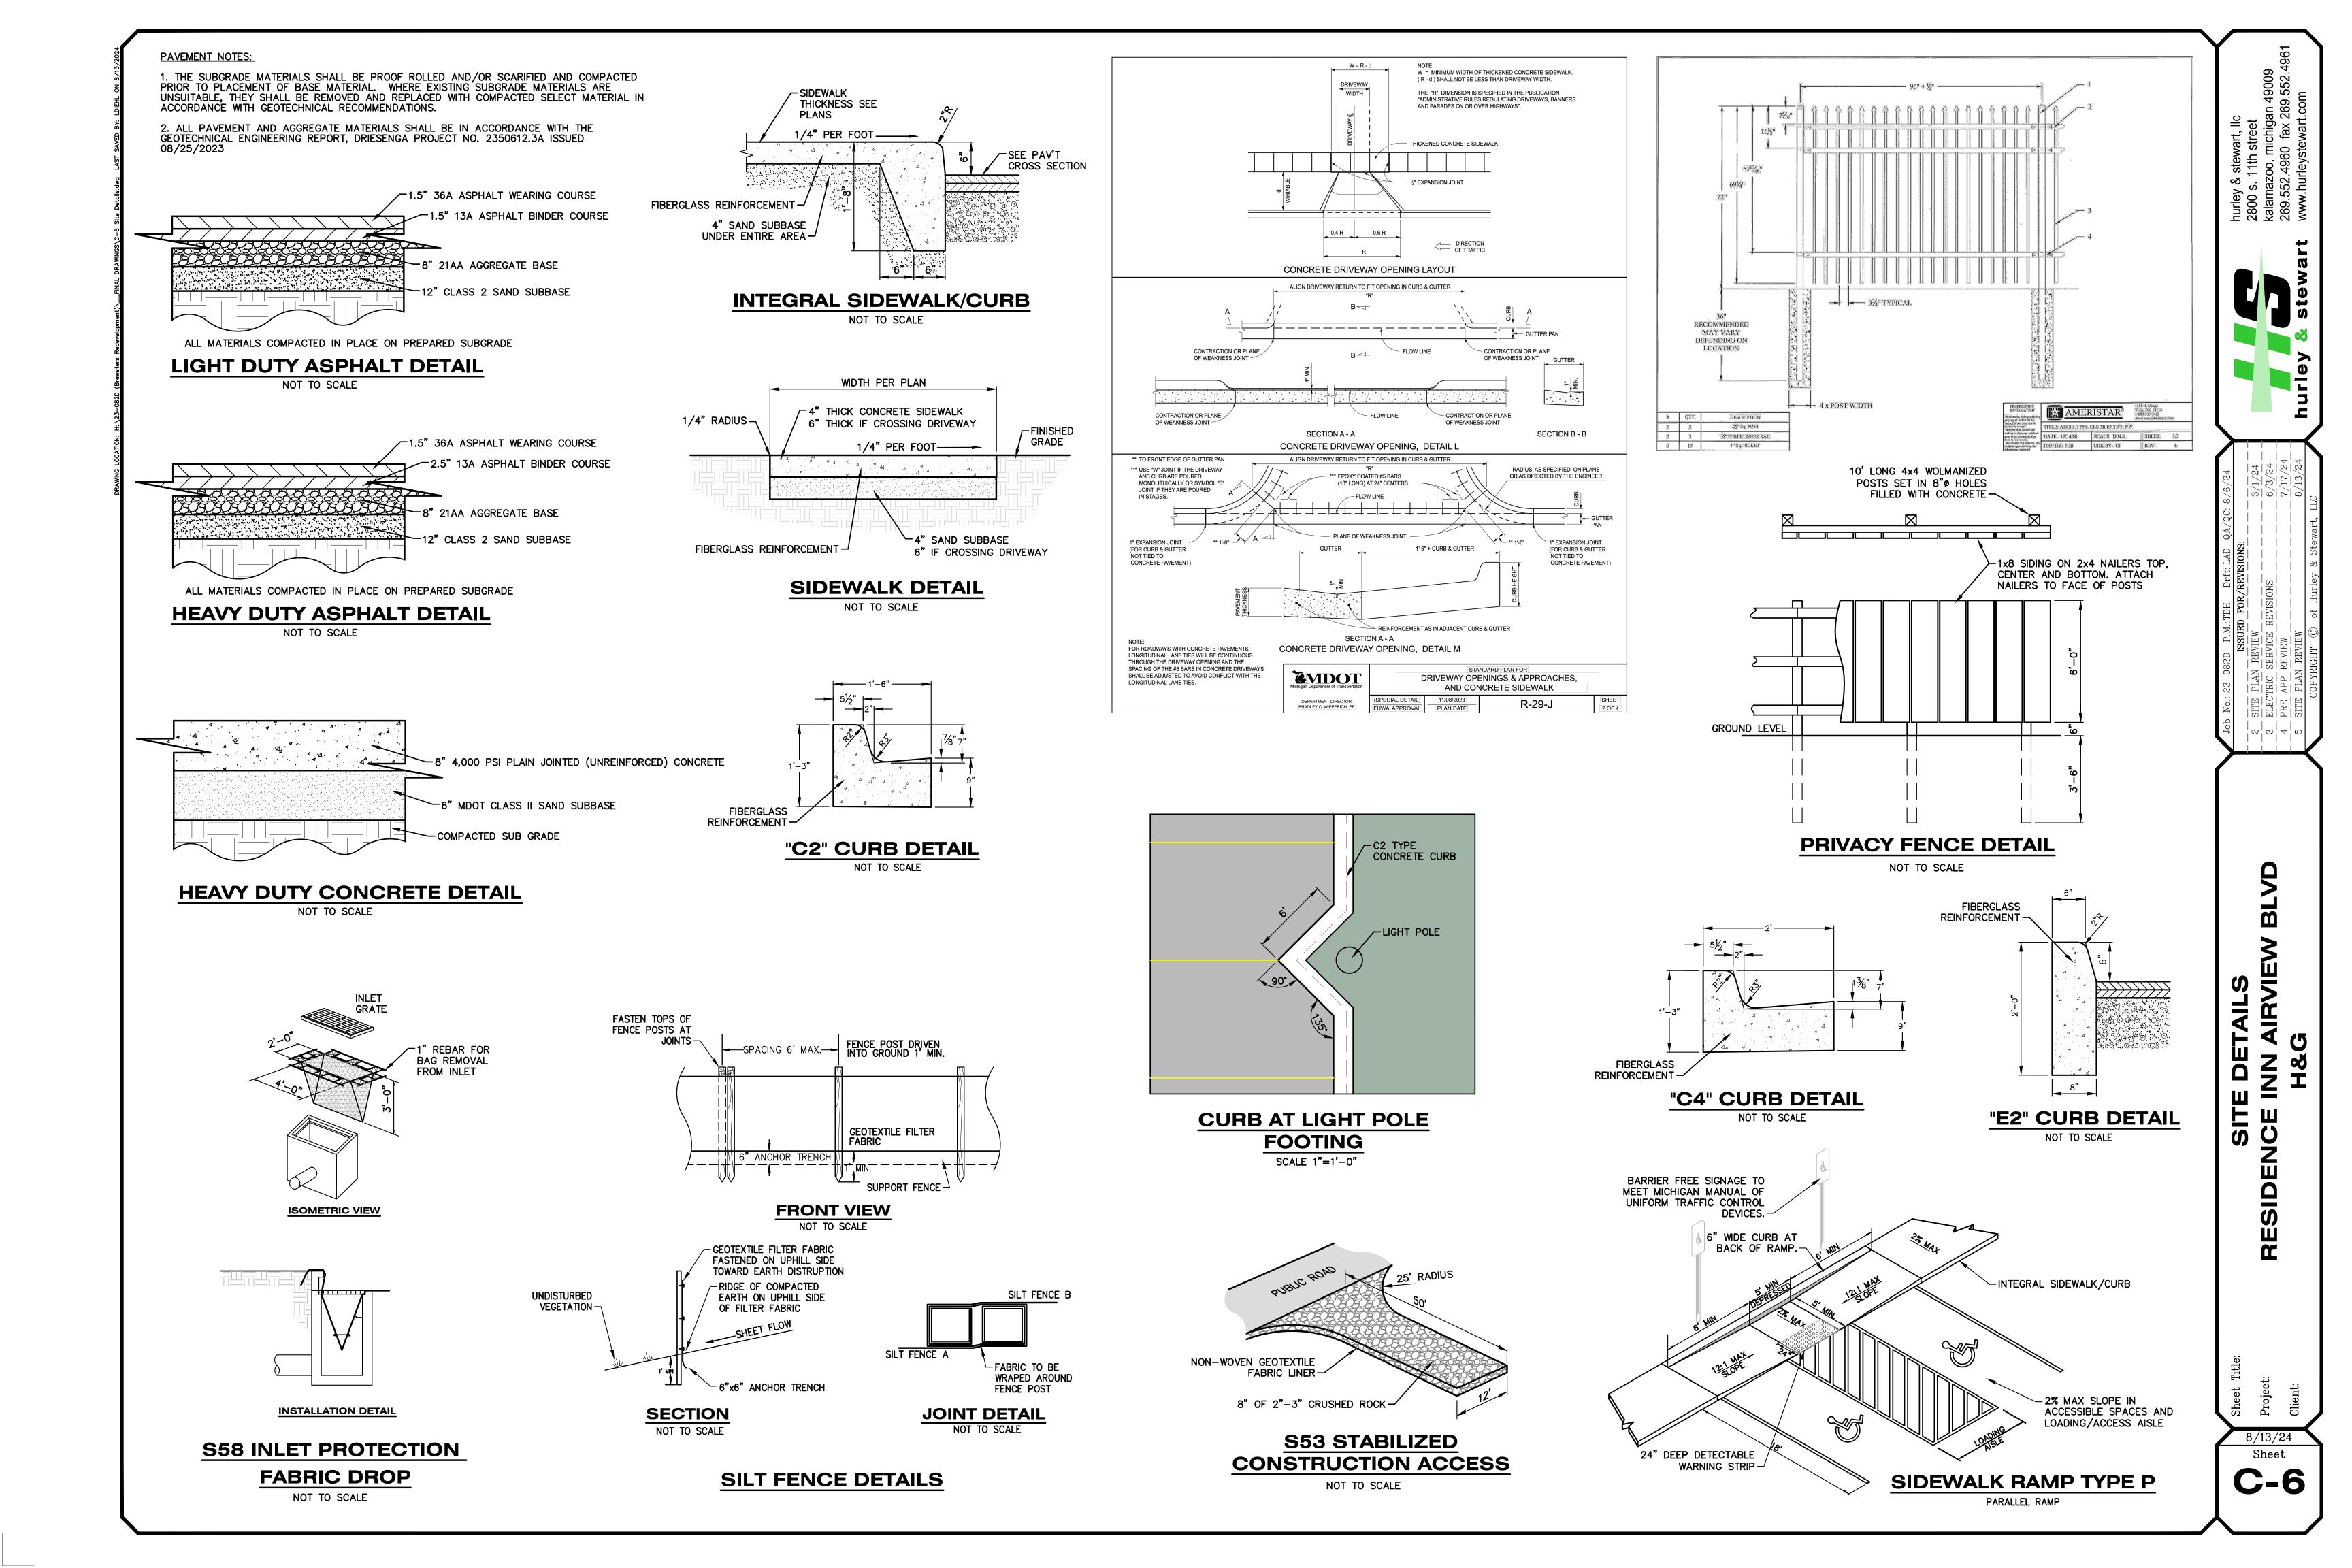


CLEANOUT IN PAVEMENT/CONC AREA NO SCALE



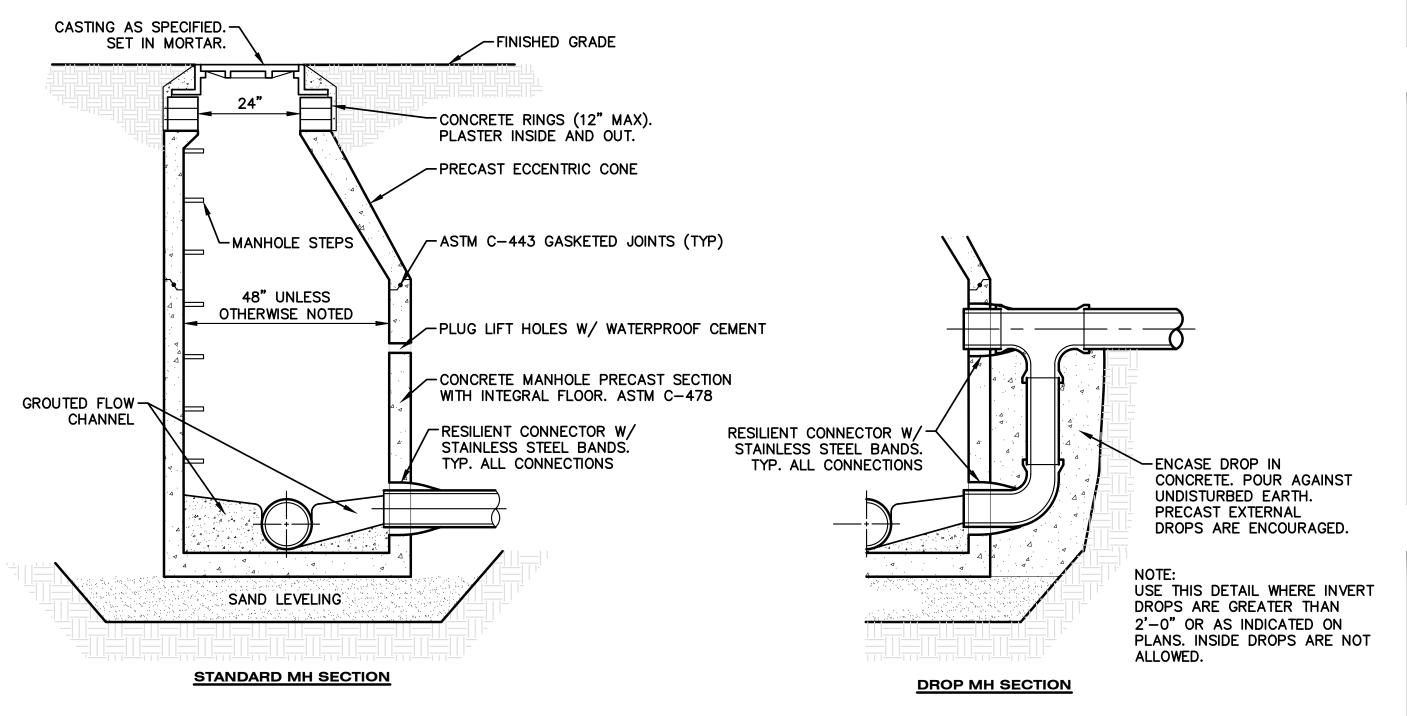

SANITARY MANHOLE DETAILS

NOT TO SCALE

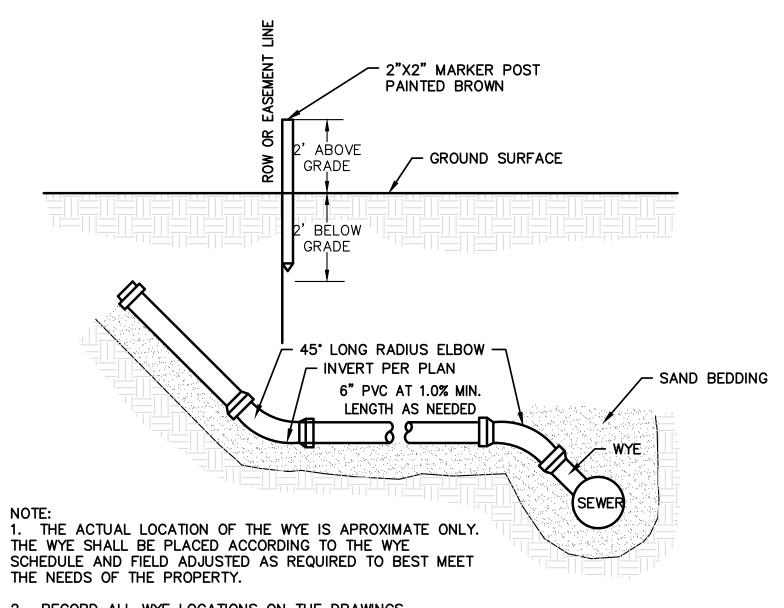

2. RECORD ALL WYE LOCATIONS ON THE DRAWINGS.


SANITARY LEAD DETAIL

NO SCALE


7 **AIRVIEW** NCE RESIDI


8/13/24

 Sheet

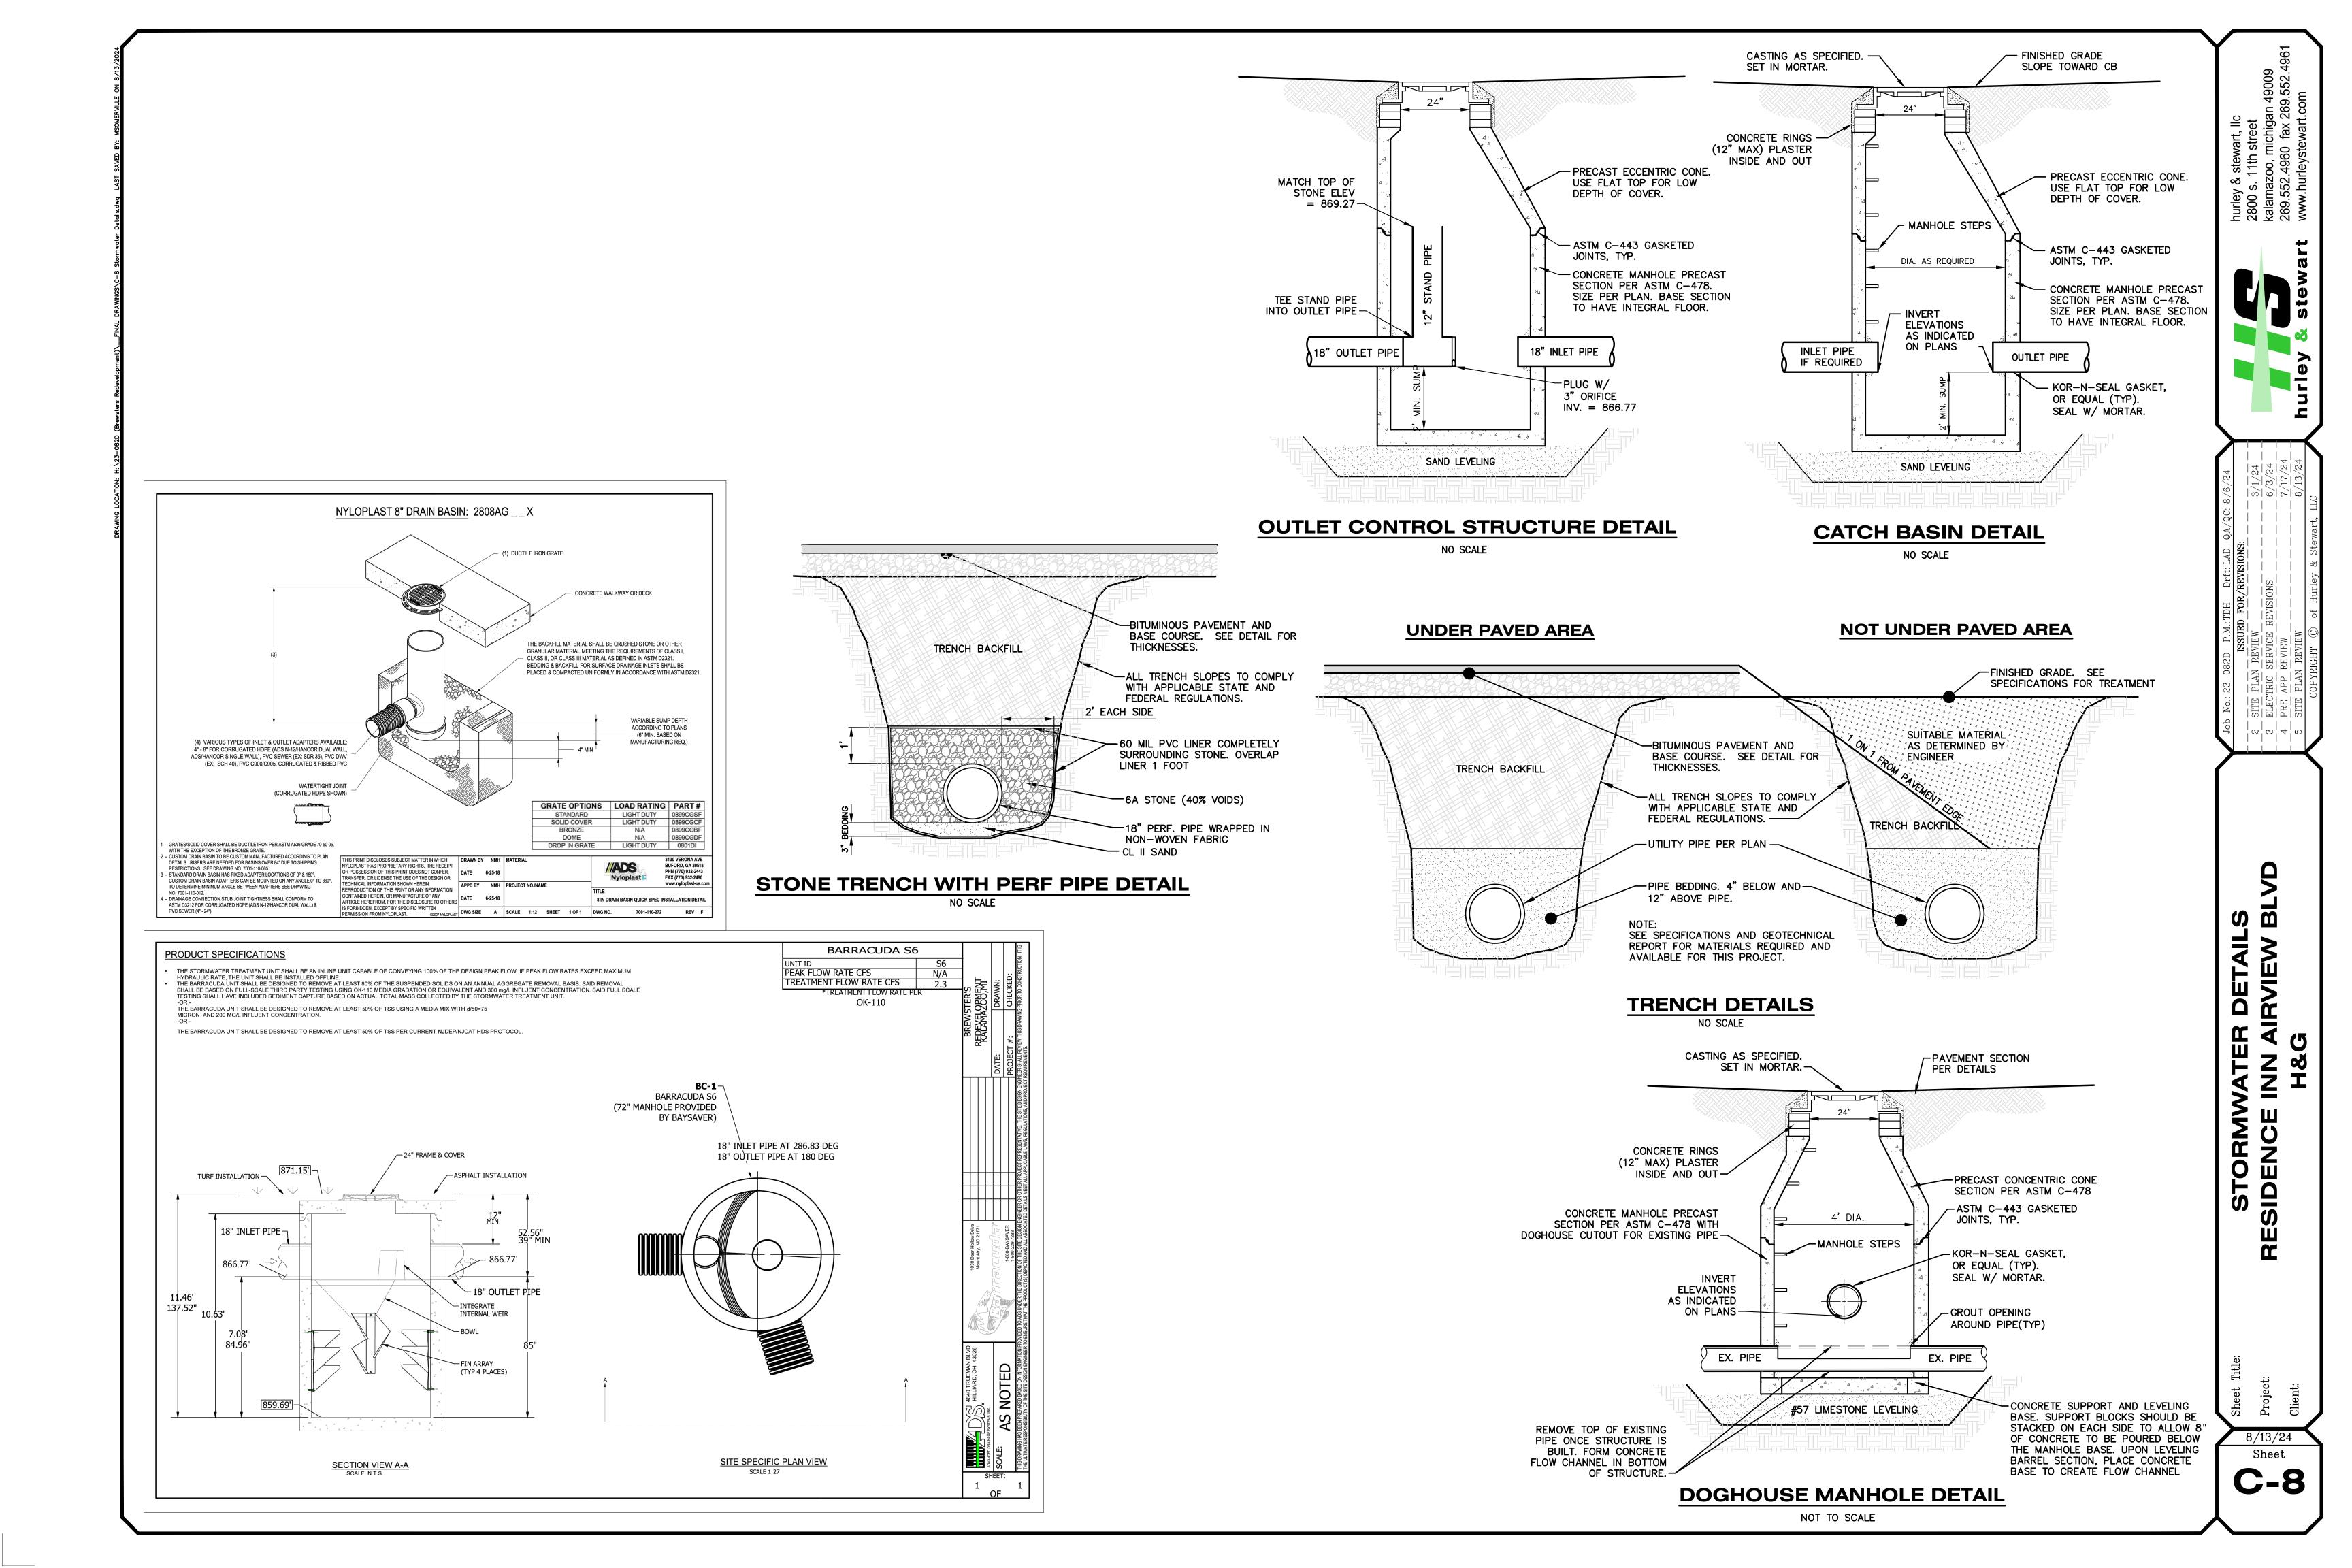

		Planting Schedule	Trees		
Symbol	<u>Latin Name</u>	<u>Common Name</u>	<u>Size</u>	<u>Container Type</u>	<u>Comments</u>
Ар	Acer palmatum 'Shishigashira'	Shishigashira Japanese Maple	2" Cal.	B&B	
Ag Amelanchier x gradiflora 'Autumn Brilliance'		Autumn Brilliance Serviceberry	7' Ht.	B&B	Clump Form 3—5 stems.
Cj	Cercidiphyllum japonicum	Katsura Tree	2" Cal.	B&B	
Cn	Chamaecyparis nootkatensis 'Pendula'	Weeping Nootka Cypress	6' Ht.	В&В	
Gt	Gleditsia triacanthos inermis 'Suncole'	Sunburst Honeylocust	2 ½" Cal.	В&В	
Lss	Liquidamber styraciflua 'Slender Silhouette'	Columnar Sweet Gum	2 1/2" Cal.	В&В	
MI	Magnolia x loebneri 'Merrill'	Dr. Merrill Magnolia	2 1/2" Cal.	B&B	Tree Form
Ро	Picea omorika	Serbian Spruce	6'-10' Ht.	В&В	3 different sized trees equally distributed
Qr	Quercus robur 'Fastigiata'	Pyramidal English Oak	3" Cal.	B&B	
Zs	Zelkova serrata 'Green Vase'	Green Vase Zelkova	2 1/2" Cal.	B&B	
		Planting Schedule	Shrubs		
Symbol	<u>Latin Name</u>	<u>Common Name</u>	<u>Size</u>	<u>Container Type</u>	<u>Comments</u>
Cas	Cornus alba 'Sibirica'	Red Twig Dogwood	30" Ht.	Cont.	
Ca	Clethra alnifolia 'Sixteen Candles'	Sixteen Candles Summersweet	30" Ht.	Cont.	
Cs	Chaenomeles speciosa 'Texas Scarlet	Texas Scarlet Flowering Quince	24" Ht.	B&B or Cont.	
Fm	Fothergilla major 'Mt. Airy'	Mt. Airy Fothergilla	30" Ht.	Cont.	

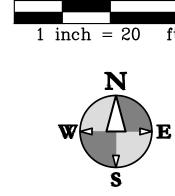

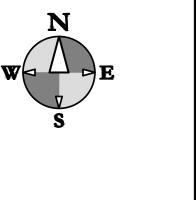

<u>Symbol</u>	<u>Latin Name</u>	<u>Common Name</u>	<u>Size</u>	<u>Container Type</u>	<u>Comments</u>
Cas	Cornus alba 'Sibirica'	Red Twig Dogwood	30" Ht.	Cont.	
Ca	Clethra alnifolia 'Sixteen Candles'	Sixteen Candles Summersweet	30" Ht.	Cont.	
Cs	Chaenomeles speciosa 'Texas Scarlet	Texas Scarlet Flowering Quince	24" Ht.	B&B or Cont.	
Fm	Fothergilla major 'Mt. Airy'	Mt. Airy Fothergilla	30" Ht.	Cont.	
lm	llex x meserveae 'Mesog' & 'Mesdob'	China Girl and China Boy Holly	36" Ht.	В&В	Plant one China Boy for every 4 China Girl shrubs.
lg	llex glabra 'Compacta'	Compact Inkberry	24" Ht.	Cont.	
lv	Itea virginica 'Henry's Garnet'	Henry's Garnet Sweetspire	24" Ht	Cont.	Well branched shrubs
Js	Juniperus sabina 'Broadmoor'	Broadmoor Juniper	24" spread	Cont.	
Jsg	Juniperus sabina 'Gray Gleam'	Gray Glean Juniper	6' Ht.	B&B	
Pa	Picea abies 'Little Gem'	Little Gen Norway Spruce	18" Ht.	B&B or Cont.	
Rp	Rhododendron x 'PJM'	PJM Rhododendron	30" Ht.	Cont.	
Ra	Rhus aromatica 'Gro—Low'	Gro—Low Aromatic Sumac	24" spread	Cont.	
То	Thuja occidentalis 'Degroot's Spire'	Degroot's Spire Arborvitae	5' Ht.	B&B or Cont.	
Vn	Viburnum nudum 'Winterthur'	Winterthur Viburnum	30" Ht.	Cont.	
Vr	Viburnum x rhytidophylloides 'Allegheny'	Allegheny Viburnum	42" Ht.	Cont.	
		Planting Schedule P	erennials		

Planting	Schedule	Perenni	als
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	Flanting Ochedule Ferenmais									
<u>Symbol</u>	mbol <u>Latin Name</u> <u>Common Name</u> <u>Size</u> <u>Container Type</u> <u>Comments</u>									
Am	Allium 'Millenium'	Millennium Ornamental Onion	#1	Cont.						
Ер	Echinacea purpurea	Purple Coneflower	#1	Cont.	15" o.c.					
Er	Eupatorium rugosum 'Chocolate'	Chocolate Joe—Pye	#1	Cont.	24" o.c.					
Hh	Heuchera hybrid 'Wildberry'	Dolce 'Wildberry' Coral Bells	#1	Cont						
Hk	Hosta 'Krosa Regal'	Krosa Regal Hosta	#1	Cont.	30" o.c.					
Ls	Liriope spicata	Creeping Lily—turf	cell	flat of 38	8" o.c.					
Ms	Miscanthus sinensis 'Gold Breeze'	Gold Breeze Silver Grass	#1	Cont.	36" o.c.					
Msm	Miscanthus sinensis 'Malepartus'	Malepartus Silver Grass	#1	Cont.	36" o.c.					
Par	Pennisetum alopecuroides 'Red Head'	Fountain Grass 'Red Head'	#1	Cont.	24" o.c.					

LANDSCAPE NOTES:

- 1. LAWN AREAS TO BE PLANTED WITH UPLAND MINERAL SOIL GROWN BLUEGRASS SOD. SOD TO HAVE BEEN HARVESTED WITHIN 24 HOURS OF PLANTING. ENSURE A
- SOURCE OF WATER BEFORE SCHEDULING SOD PLANTING. PREPARE SOIL TO RECEIVE SOD WITH A 19-19-19 STARTER FERTILIZER AT A RATE OF 5-7 LBS/1000 SFT. 2. ALL EDGING SHALL BE STANDARD COMMERCIAL-STEEL EDGING 3/6" X 4", ROLLED EDGE, FABRICATED IN SECTIONS OF STANDARD LENGTHS, WITH LOOPS STAMPED FROM OR WELDED
- TO FACE OF SECTIONS TO RECEIVE STAKES IN STANDARD FINISH OF GREEN PAINT.
- 3. PROVIDE QUALITY, SIZE, GENUS, SPECIES, AND VARIETY OF EXTERIOR PLANTS INDICATED, COMPLYING WITH APPLICABLE REQUIREMENTS IN ANSI Z60.1 "AMERICAN STANDARD FOR NURSERY STOCK." MEASURE ACCORDING TO ANSI Z60.1 STANDARDS.
- 4. WARRANT TREES, SHRUBS AND PERENNIALS FOR ONE YEAR FROM DATE OF SUBSTANTIAL COMPLETION AGAINST DEFECTS INCLUDING DEATH AND UNSATISFACTORY GROWTH, EXCEPT FOR DEFECTS RESULTING FROM INCIDENTS THAT ARE BEYOND CONTRACTOR'S CONTROL.
- 5. REMOVE AND REPLACE DEAD PLANTS IMMEDIATELY. REPLACE PLANTS THAT ARE MORE THAN 25% DEAD OR IN AN UNHEALTHY CONDITION AT END OF WARRANTY
- PERIOD. A LIMIT OF ONE REPLACEMENT OF EACH PLANT WILL BE REQUIRED, EXCEPT FOR LOSSES OR REPLACEMENTS DUE TO FAILURE TO COMPLY WITH 6. MAINTAIN TREES, SHRUBS, AND PERENNIALS FOR ONE YEAR FROM DATE OF SUBSTANTIAL COMPLETION BY PRUNING, CULTIVATING, WATERING, WEEDING, FERTILIZING,
- RESTORING PLANTING SAUCERS, TIGHTENING AND REPAIRING STAKES AND GUY SUPPORTS, AND RESETTING TO PROPER GRADES OR VERTICAL POSITION, AS REQUIRED TO ESTABLISH HEALTHY VIABLE PLANTINGS. SPRAY AS REQUIRED TO KEEP TREES AND SHRUBS FREE OF INSECTS AND DISEASE.
- 7. BEGIN LAWN MAINTENANCE IMMEDIATELY AFTER EACH AREA IS PLANTED AND CONTINUE UNTIL ACCEPTABLE LAWN IS ESTABLISHED: A MINIMUM OF 60 DAYS AFTER SUBSTANTIAL COMPLETION.
- 8. MAINTAIN AND ESTABLISH LAWN BY WATERING, FERTILIZING, WEEDING, USING CHEMICAL TREATMENT TO ELIMINATE BROADLEAF AND NOXIOUS WEEDS, MOWING, TRIMMING,
- REPLANTING, AND OTHER OPERATIONS. ROLL, REGRADE, AND REPLANT BARE OR ERODED AREAS AND REMULCH TO PRODUCE A UNIFORMLY SMOOTH LAWN. 9. REMOVE STONES LARGER THAN 1" IN ANY DIMENSION AND REMOVE STICKS, ROOTS, RUBBISH, AND OTHER EXTRANEOUS MATTER FROM SITE.
- 10. MAINTAIN LAWN UNTIL A HEALTHY, UNIFORM, CLOSE STAND OF GRASS HAS BEEN ESTABLISHED, FREE OF WEEDS AND SURFACE IRREGULARITIES, WITH COVERAGE
- EXCEEDING 90% OVER ANY 10 SQFT AND BARE SPOTS DO NOT EXCEED 5 BY 5 INCHES. 11. DO NOT PLACE STONE COBBLE DURING WET WEATHER. DO NOT PLACE DIRTY OR MUDDY COBBLE ON BARRIER FABRIC.
- 12. APPLY PRE-EMERGENT HERBICIDE TO ALL PLANTING BEDS ACCORDING TO MANUFACTURER'S RECOMMENDATIONS REAPPLY AS RECOMMENDED BY PRODUCT DURING ONE YEAR WARRANTY PERIOD.

LEGEND



NUMBER AND TYPE OF PLANTS TO BE PROVIDED AND INSTALLED.



SEEDED LAWN.

PERENNIAL PLANTING. SEE PLANTING SCHEDULE FOR PLANT SPACING REQUIREMENTS.



STONE COBBLE MULCH 2-3" DIA. NATURAL STONE COBBLE WASHED OVER FILTER FABRIC.



PROPOSED DECIDUOUS TREE




PROPOSED EVERGREEN TREE





PROPOSED SHRUBS, EVERGREEN AND DECIDUOUS

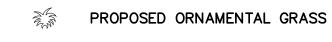

STEEL LANDSCAPE EDGING.

IRRIGATION NOTES:

- 1. LANDSCAPE CONTRACTOR TO PROVIDE LAYOUT AND DETAILS FOR FULL
- IRRIGATION SYSTEM PRIOR TO INSTILLATION.
- 2. ALL LANDSCAPE AREAS AND LAWNS ADJACENT TO PAVED AREAS AND/OR STREETS ARE TO BE FULLY IRRIGATED.
- 3. IRRIGATION SYSTEM TO INCLUDE ALL SPRAY HEADS, VALVES AND CONTROLLERS.
- 4. A SEPARATE METER AND BACKFLOW PREVENTER WILL BE REQUIRED.
- 5. LOCATE HEADS A MINIMUM OF 2'-0" FROM EDGE OF PAVEMENT/ CURB.

KALAMAZOO PLANTING REQUIREMENTS

1 TREE / 35 LFT OF ROW = 349' AND 235' = 9 TREES (PORTAGE RD) 8 TREES (AIRVIEW BLVD) 5% INTERIOR LANDSCAPE REQUIRED 33,356 SF \times .05 = 1,668 SF REQUIRED 1,886 SF PROVIDED 3 SHRUB/ 20' ROAD FRONTAGE AT PARKING =(118 LF/20)3 = 18 SHRUBS1 SHRUB/ 5' BUILDING FACADE = 375 LF/5 = 75 SHRUBS

1 TREE / 300 SQFT OF REQUIRED INTERIOR = 6 TREES

1 CANOPY TREE / FRACTION OF AN ACRE = 2 TREES (TREES PLANTED TO MEET OTHER REQUIRED LANDSCAPE AND SCREENING REQUIREMENTS MAY BE APPLIED TO MEET THE TREE CANOPY REQUIREMENT. CHAPTER 50, 50-8.4B (5))



Call before you dig.

ALL UTILITIES AS SHOWN ARE APPROXIMATE LOCATIONS DERIVED FROM ACTUAL MEASUREMENTS AND AVAILABLE RECORDS. THEY SHOULD NOT BE INTERPRETED TO BE EXACT LOCATION NOR SHOULD IT BE ASSUMED THAT THEY ARE THE ONLY UTILITIES IN THE AREA.

FIELD WORK PERFORMED BY: HURLEY & STEWART, LLC

8/13/24 Sheet


Z

CONCRETE COLLAR

FOR LANDSCAPE

DIAMOND


NOT TO SCALE

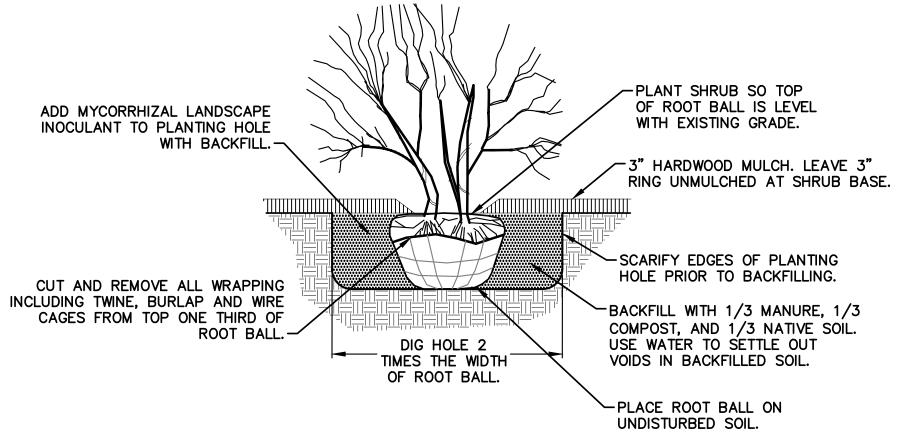

TYPICAL SHRUB DETAIL


NOT TO SCALE

STAKING OF BALL AND BURLAP TREES REQUIRED AT THE DISCRETION OF THE CONTRACTOR. CONTRACTOR IS RESPONSIBLE FOR REMOVAL OF ALL STAKING AT END OF ONE YEAR WARRANTY PERIOD.

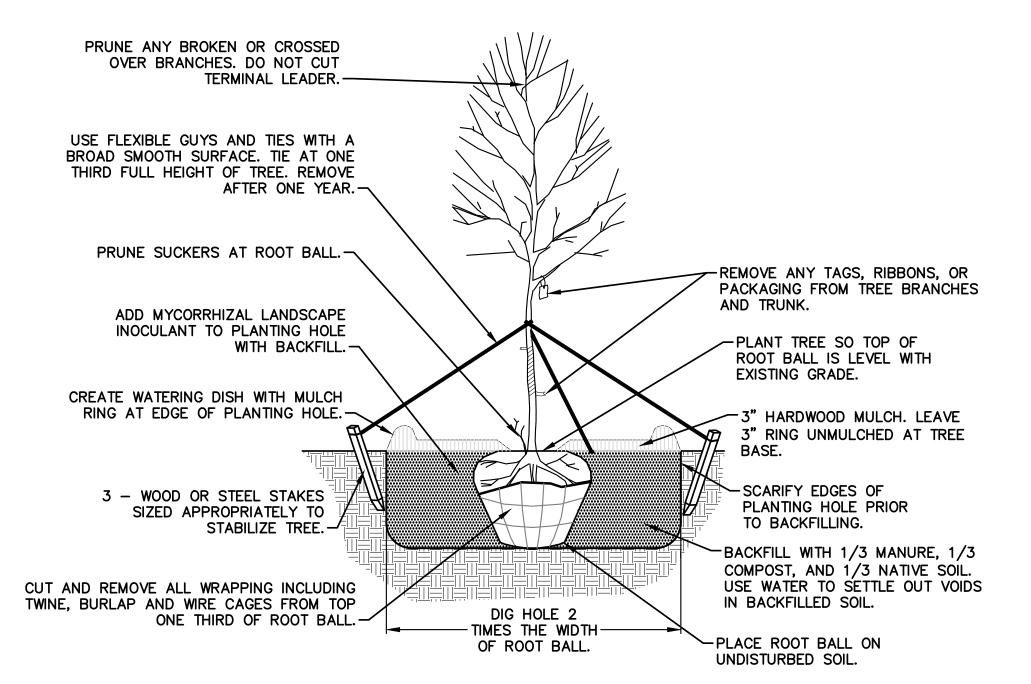

DECIDUOUS TREE

NOT TO SCALE

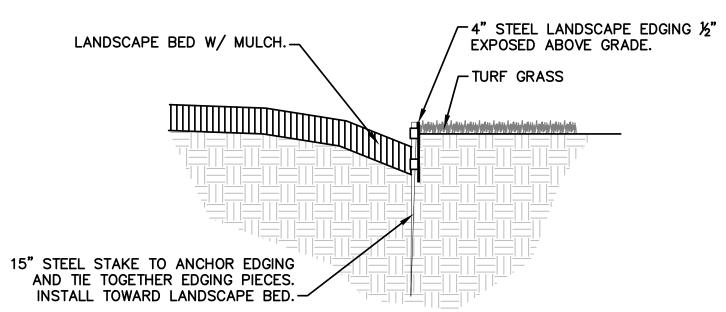

STEEL LANDSCAPE **EDGING DETAIL**

NOT TO SCALE

8/13/24

SIDENC

Sheet

- 2. CONTOUR INTERVAL = 1 FOOT
- UTILITIES SHOWN ARE BASED ON FIELD LOCATION OF SURFACE EVIDENCE AND RECORDS PROVIDED BY OTHERS. UNDERGROUND UTILITY LOCATIONS ARE APPROXIMATE. ADDITIONAL UTILITIES MAY BE ENCOUNTERED. PRIOR TO ANY EXCAVATION THE CONTRACTOR SHALL CALL MISS DIG AT

BASIS OF BEARINGS: MICHIGAN STATE PLANE COORDINATE SYSTEM, SOUTH ZONE, NAD 83

- 4. THERE IS NEW SIDEWALK AND PAVEMENT ALONG PORTAGE ROAD AND E KILGORE SERVICE ROAD AND ACCESS DRIVE TO THE NORTH.
- 5. THERE ARE NO KNOWN CHANGES PROPOSED TO THE STREET RIGHT OF WAY LINES.
- BY SCALED MAP LOCATION AND GRAPHIC PLOTTING ONLY, THE LAND DEPICTED IN THIS SURVEY LIES IN ZONE X. MAP 6077C0310D, EFFECTIVE DATE 2/17/2010.
- NO WETLANDS ON SITE PER THE NATIONAL WETLANDS INVENTORY. A DELINEATION OF THE WETLANDS BY A QUALIFIED CONSULTANT WAS NOT PERFORMED AT THE TIME OF SURVEY.
- 8. PARCEL CONTAINS 1.83± ACRES (79,513± SQFT)
- . THERE ARE 109 PARKING SPACES AND 4 BARRIER FREE PARKING SPACES FOR A TOTAL OF 113
- 10. THERE WAS NO EVIDENCE OF RECENT EARTH MOVING WORK, BUILDING CONSTRUCTION, OR BUILDING ADDITIONS OBSERVED IN THE PROCESS OF CONDUCTING THE FIELDWORK.

SCHEDULE "A" LEGAL DESCRIPTION

TITLE CO: SUN TITLE AGENCY OF MICHIGAN, LLC UNDERWRITTEN BY: OLD REPUBLIC NATIONAL TITLE INSURANCE COMPANY COMMITMENT NO. 222858 EFFECTIVE DATE 6/15/2023 AT 8:00AM

THE LAND REFERRED TO IN THIS COMMITMENT IS DESCRIBED AS FOLLOWS: LAND SITUATED IN THE CITY OF KALAMAZOO, KALAMAZOO COUNTY, MICHIGAN:

COMMENCING AT THE NORTH 1/4 CORNER OF SECTION 2, TOWN 3 SOUTH, RANGE 11 WEST; THENCE SOUTHERLY 980 FEET ALONG THE NORTH-SOUTH 1/4 LINE OF SAID SECTION 2 TO THE POINT OF BEGINNING; THENCE NORTH 89 DEGREES 24 MINUTES 10 SECONDS EAST 210 FEET AS MEASURED AT RIGHT ANGLES TO THE NORTH-SOUTH 1/4 LINE OF SAID SECTION 2; THENCE SOUTH 00 DEGREES 35 MINUTES 50 SECONDS EAST 150 FEET PARALLEL TO SAID NORTH-SOUTH 1/4 LINE; THENCE SOUTH 89 DEGREES 24 MINUTES 10 SECONDS WEST 210 FEET TO SAID NORTH-SOUTH 1/4 LINE AND MEASURED AT RIGHT ANGLES TO SAID NORTH-SOUTH 1/4 LINE; THENCE NORTH 00 DEGREES 35 MINUTES 50 SECONDS WEST 150 FEET ALONG SAID NORTH-SOUTH 1/4 LINE TO THE PLACE OF BEGINNING. EXCEPTING THE WESTERLY 60 FEET THEREOF FOR PORTAGE ROAD.

ALSO EXCEPTING THE FOLLOWING DESCRIBED PARCEL: COMMENCING AT THE NORTH 1/4 CORNER OF SECTION 2, TOWN SOUTH, RANGE 11 WEST; THENCE SOUTH 00 DEGREES 33 MINUTES 54 SECOND WEST 1130.00 FEET ALONG THE NORTH-SOUTH 1/4 LINE OF SAID SECTION 2 TO THE INTERSECTION OF THE NORTH RIGHT-OF-WAY LINE OF THE ORIGINAL FAIRFIELD AVENUE AS EXTENDED WEST; THENCE SOUTH 89 DEGREES 26 MINUTES 06 SECONDS EAST 60.0 FEET ALONG SAID LINE TO THE EAST RIGHT-OF-WAY LINE OF PORTAGE ROAD FOR THE PLACE OF BEGINNING OF THIS EXCLUSION; THENCE NORTH 00 DEGREES 33 MINUTES 54 SECONDS EAST 30.62 FEET ALONG THE EAST LINE OF PORTAGE ROAD; THENCE SOUTH 54 DEGREES 45 MINUTES 10 SECONDS EAST 8.53 FEET; THENCE SOUTH 00 DEGREES 33 MINUTES 54 SECONDS WEST 6.08 FEET; THENCE SOUTH 54 DEGREES 45 MINUTES 10 SECONDS EAST 10.17 FEET; THENCE SOUTH 80 DEGREES 46 MINUTES 45 SECONDS EAST 39.00 FEET; THENCE SOUTH 83 DEGREES 54 MINUTES 57 SECONDS EAST 36.77 FEET; THENCE SOUTH 89 DEGREES 26 MINUTES 20 SECONDS EAST 59.47 FEET; THENCE SOUTH 00 DEGREES 33 MINUTES 54 SECONDS WEST 4.50 FEET TO THE NORTH RIGHT-OF-WAY LINE OF THE ORIGINAL FAIRFIELD AVENUE; THENCE NORTH 89 DEGREES 26 MINUTES 06 SECONDS WEST 150 FEET ALONG SAID LINE TO THE PLACE OF BEGINNING.

39-10-02-215-005

COMMENCING AT THE NORTH 1/4 CORNER OF SECTION 2, TOWN 3 SOUTH, RANGE 11 WEST; THENCE SOUTH 00 DEGREES 35 MINUTES 50 SECONDS EAST 775 FEET ALONG THE NORTH-SOUTH 1/4 LINE OF SAID SECTION 2 TO THE POINT OF BEGINNING; THENCE NORTH 89 DEGREES 51 MINUTES 10 SECONDS EAST 295.62 FEET; THENCE SOUTH 00 DEGREES 35 MINUTES 50 SECONDS EAST 352.68 FEET PARALLEL TO SAID NORTH-SOUTH 1/4 LINE: THENCE SOUTH 89 DEGREES 24 MINUTES 10 SECONDS WEST 85.61 FEET; THENCE NORTH 00 DEGREES 35 MINUTES 50 SECONDS WEST 150 FEET; THENCE SOUTH 89 DEGREES 24 MINUTES 10 SECONDS WEST 210 FEET TO SAID NORTH-SOUTH 1/4 LINE OF SAID SECTION 2; THENCE NORTH 00 DEGREES 35 MINUTES 50 SECONDS WEST 205 FEET ALONG SAID NORTH-SOUTH1/4 LINE TO THE


EXCEPTING THAT PORTION IN PORTAGE ROAD.

ALSO EXCEPTING THE FOLLOWING DESCRIBED PARCEL: COMMENCING AT THE NORTH 1/4 CORNER OF SECTION 2. TOWN 3 SOUTH, RANGE 11 WEST; THENCE SOUTH 00 DEGREES 33 MINUTES 54 SECONDS WEST 1130.00 FEET ALONG THE NORTH-SOUTH 1/4 LINE OF SAID SECTION 2 TO THE INTERSECTION OF THE NORTH RIGHT-OF-WAY LINE OF TH ORIGINAL FAIRFIELD AVENUE AS EXTENDED WEST; THENCE SOUTH 89 DEGREES 26 MINUTES 06 SECONDS EAST 210.0 FEET ALONG SAID LINE TO THE EAST RIGHT-OF-WAY LINE OF PORTAGE ROAD FOR THE POINT OF BEGINNING OF THIS EXCEPTION: THENCE NORTH OO DEGREES 33 MINUTES 54 SECONDS EAST 6.00 FEET: THENCE SOUTH 89 DEGREES 26 MINUTES 06 SECONDS EAST 85.61 FEET; THENCE SOUTH 00 DEGREES 33 MINUTES 54 SECONDS WEST 6.00 FEET TO THE NORTH RIGHT-OF-WAY LINE OF THE ORIGINAL FAIRFIELD AVENUE; THENCE NORTH 89 DEGREES 26 MINUTES 06 SECONDS WEST 85.61 FEET ALONG SAID LINE TO THE PLACE OF BEGINNING. 39-10-02-215-006



COMMUNICATION MANHOLE

TOPOGRAPHIC SURVEY

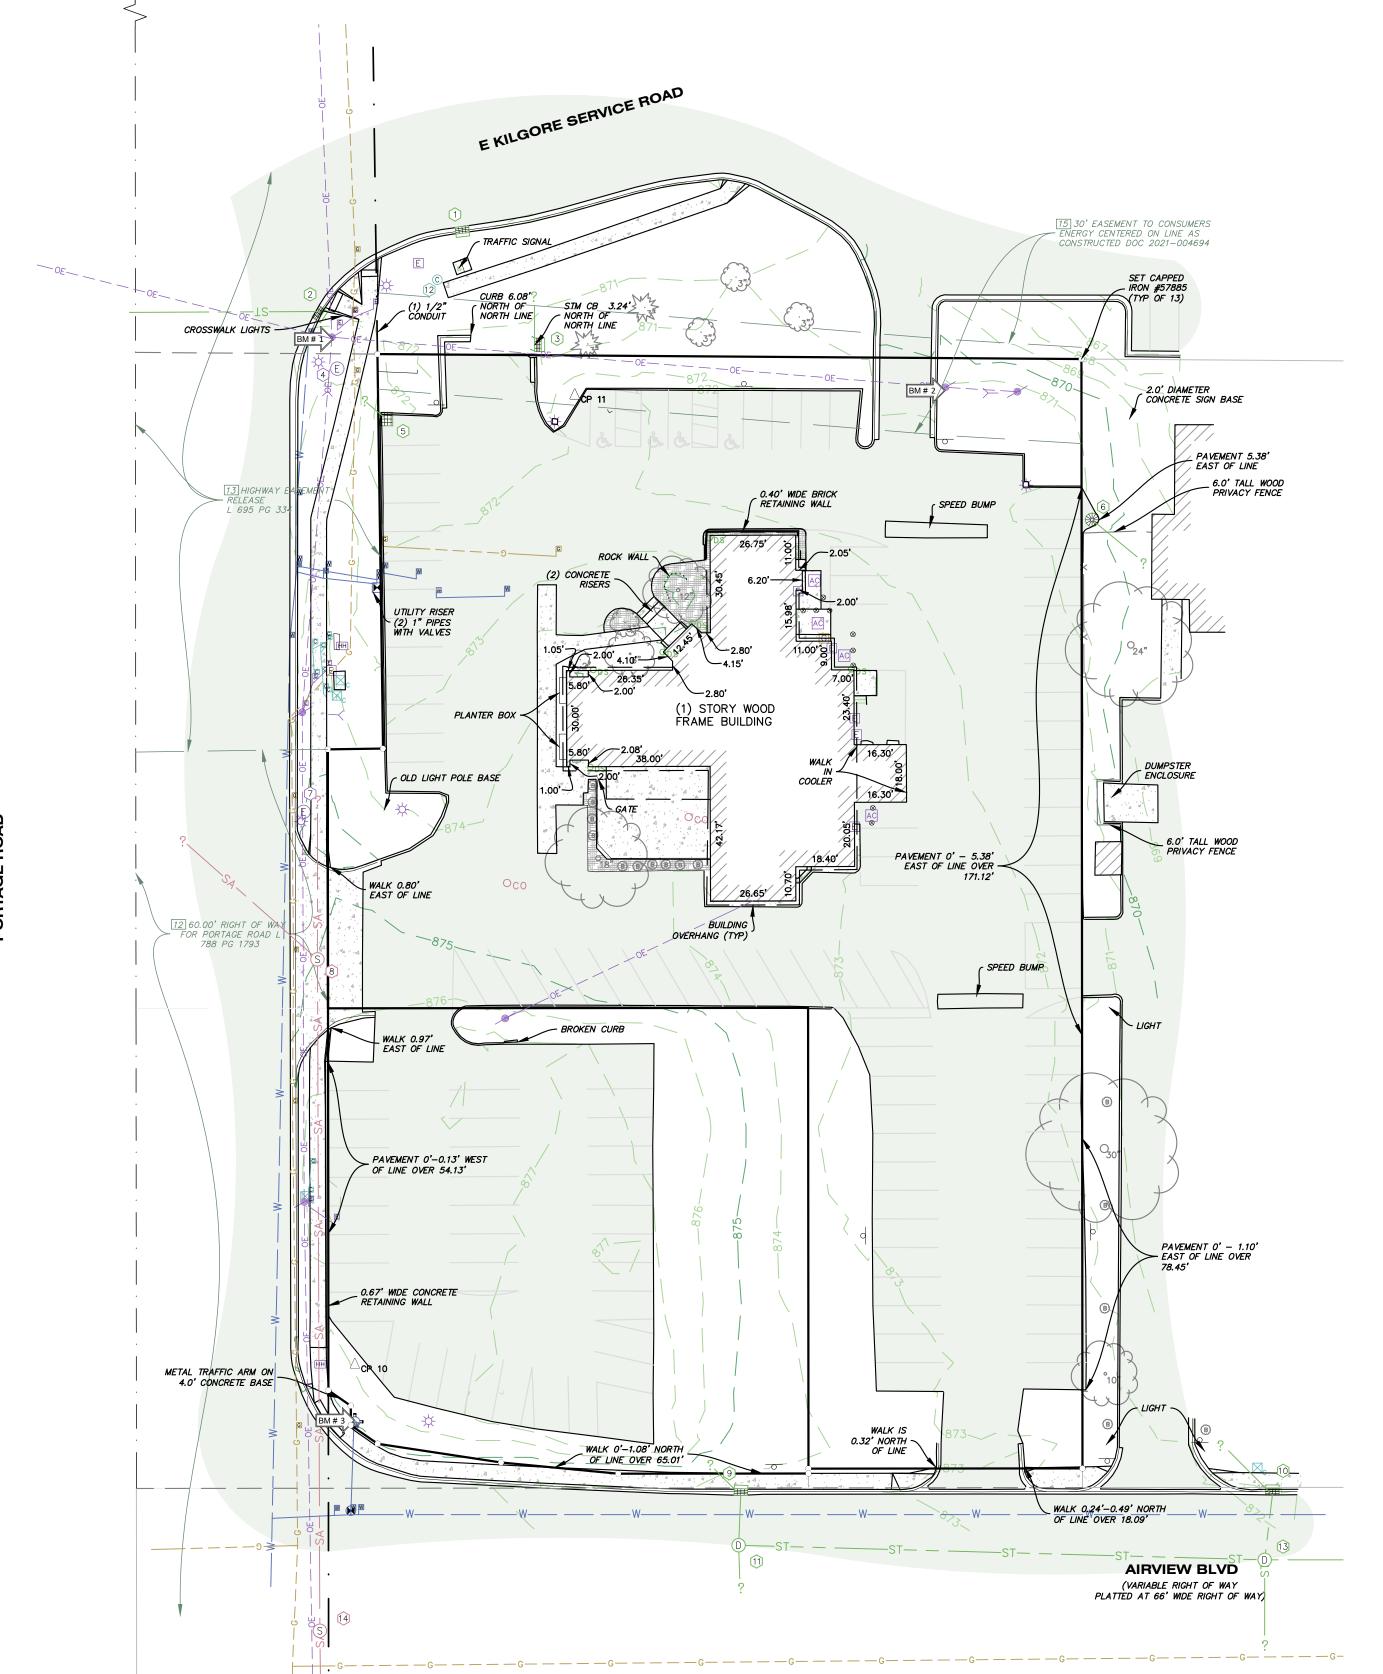

MISS DIG DESIGN TICKET DATA

AT&T TELEPHONE - 616-881-2268 - NO RESPONSE - 08/15/23

COMCAST CABLE TV - 855-962-8525 - NO RESPONSE - 08/15/23

CONSUMERS ENERGY ELECTRIC - 800-778-9140 - NO RESPONSE - 08/15/23

PORTAGE CITY FIBER OPTICS - PORTAGE GIS - MAPS PROVIDED - 08/15/23

PORTAGE CITY STORM SEWER - PORTAGE GIS - MAPS PROVIDED - 08/15/23

PORTAGE CITY TRAFFIC - PORTAGE GIS - MAPS PROVIDED - 08/15/23

PORTAGE CITY SANITARY SEWER - PORTAGE GIS - MAPS PROVIDED - 08/15/23

LEVEL 3 NOW LUMEN FIBER OPTICS - 877-366-8344 - NO RESPONSE - 08/15/23

CONSUMERS ENERGY - 800-778-9140 -NO RESPONSE - 08/15/23

CHARTER COMMUNICATIONS CABLE TV - 800-778-9140 - NO RESPONSE - 08/15/23

CHARTER COMMUNICATIONS FIBER OPTICS - 800-778-9140 - NO RESPONSE - 08/15/23

CLIMAX TELEPHONE DBA METRO FIBERNET - 800-778-9140 -NO RESPONSE - 08/15/23

CONSUMERS ENERGY GAS - CONSUMERS ENERGY SIMS WEBSITE - MAPS PROVIDED - 08/15/23

KALAMAZOO CITY DPS POTABLE WATER - WILL EICHELBERGER 269-337-8727 - MAPS PROVIDED - 08/14/23

KALAMAZOO CITY DPS SANITARY SEWER - WILL EICHELBERGER 269-337-8727 - MAPS PROVIDED - 08/14/23

KALAMAZOO CITY DPS STORM SEWER - WILL EICHELBERGER 269-337-8727 - MAPS PROVIDED - 08/14/23

KALAMAZOO CITY DPS TRAFFIC - WILL EICHELBERGER 269-337-8727 - MAPS PROVIDED - 08/14/23

SCHEDULE B SECTION II EXCEPTIONS TITLE CO: SUN TITLE AGENCY OF MICHIGAN, LLC

NORTH QUARTER CORNER SECTION 2, TO3S, R11W

COMMITMENT NO. 222858 EFFECTIVE DATE 6/15/2023 AT 8:00AM 12 TERMS, COVENANTS, AND CONDITIONS OF WARRANTY DEED, AS RECORDED IN LIBER 788 ON PAGE 1793 (60' ROW FOR PORTAGE RD SHOWN, AIR RESTRICTIONS NOT PLOTTABLE, EASEMENT/ROW INGRESS EGRESS TO THE "EAST-WEST

UNDERWRITTEN BY: OLD REPUBLIC NATIONAL TITLE INSURANCE COMPANY

PLOTTABLE)). 13 TERMS, COVENANTS, AND CONDITIONS OF WARRANTY DEED, AS RECORDED IN LIBER 790 ON PAGE 548 (AIR RESTRICTIONS NOT PLOTTABLE, HIGHWAY EASEMENT ADJACENT TO SURVEYED PROPERTY SHOWN).


AIRPORT TERMINAL ROAD LYING IMMEDIATELY SOUTH THEREOF" (PRESUMABLY BYRD DRIVE, NOT SHOWN/NOT

14 BUILDING AND USE RESTRICTIONS AND THE TERMS, COVENANTS, CONDITIONS AND PROVISIONS THEREIN, AS CONTAINED IN INSTRUMENT RECORDED IN LIBER 799 ON PAGE 905, WITH RELEASE, MODIFICATION AND REIMPOSITION OF RESTRICTIONS AS RECORDED IN LIBER 926 ON PAGE 224, BUT OMITTING ANY COVENANT OR RESTRICTION BASED ON RACE, COLOR, RELIGION, SEX, HANDICAP, FAMILIAL STATUS OR NATIONAL ORIGIN (NOT PLOTTABLE, NOT SURVEY

15 EASEMENT IN FAVOR OF CONSUMERS POWER COMPANY (NOW KNOWN AS CONSUMERS ENERGY), AS RECORDED IN INSTRUMENT NO. 2021-004694 (SHOWN).

SITE LOCATION MAP

NOT TO SCALE

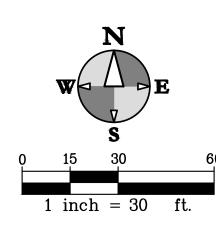

SURVEY CONTROL

CP 10 N = 11089.38 E = 10086.47 EL = 876.57CP 11 N = 11392.33 E = 10155.19 EL = 872.25

BENCHMARKS

ELEVATIONS OF THIS SURVEY ARE BASED ON NAVD 88 AS DERIVED FROM GPS

SPIKE IN EAST FACE OF UTILITY POLE AT THE SOUTHEAST CORNER OF PORTAGE ROAD AND E KILGORE SERVICE ROAD.

BM 2 EL = 872.36SPIKE IN SOUTH FACE OF UTILITY POLE ON THE EAST SIDE OF THE NORTH ACCESS DRIVE.

CHISELED X IN NORTHEAST BOLT ON HYDRANT AT THE NORTHEAST CORNER OF PORTAGE ROAD AND AIRVIEW BLVD.

EXISTING STRUCTURE DATA

① STM CB RIM = 871.10'SILT SACK FULL OF SILT

2 STM CB RIM = 871.78'

SILT SACK FULL OF SILT 3 2.0' CONCRETE STM CB RIM = 869.91'

INV. 15" N PVC = 867.56WATER = 867.56'SEDIMENT = 865.16

4 ELECTRIC MH RIM = 872.72'

5 3.0' CONCRETE STM CB RIM = 871.18'INV. 8" NW CLAY = 869.13' SEDIMENT = 869.03

6 2.0' CONCRETE STM CB RIM = 870.21'INV. 8" SE CPP = 867.86' WATER = 867.71'SUMP = 867.36'

TELECTRIC MH RIM = 874.90'

8 6.0' CONCRETE SAN MH RIM = 875.01'INV. 6" NW CLAY = 864.36' INV. 6" N CLAY = $862.11'\pm$ INV. 6" S CLAY = 862.01'

N&S PIPES ARE PLUGGED

9 4.0' CONCRETE STM CB RIM = 873.47'INV. 12" S CONCRETE = 867.72' INV. 4" NW CPP = 870.17WATER = 867.72'SEDIMENT = 866.87

10 4.0' CONCRETE STM CB RIM = 871.89'INV. 12" S CONCRETE = 866.44' INV. 4" NW CPP = 868.69' WATER = 866.34'SUMP = 864.99'

4.0' CONCRETE STM MH RIM = 873.68'INV. 12" N CONCRETE = 867.48' INV. 12" S CONCRETE = 868.33' INV. 12" E CONCRETE = 867.38' SUMP = 867.38'

12 COMMUNICATION MH RIM = 781.95'

3 4.0' CONCRETE/BLOCK STM MH RIM = 872.24'INV. 12" N CONCRETE = 866.39' INV. 12" S CONCRETE = 866.09'± INV. 12" W CONCRETE = $866.09' \pm$ INV. 15" E CONCRETE = 865.80' SUMP = 865.80'

14 4.0' CONCRETE SAN MH RIM = 874.66'INV. 6" N CLAY = 861.16' INV. 6" S CLAY = 861.11'N&S PIPES ARE PLUGGED


Know what's DCIOW. Call before you dig

ALL UTILITIES AS SHOWN ARE APPROXIMATE LOCATIONS DERIVED FROM ACTUAL MEASUREMENTS AND AVAILABLE RECORDS. THEY SHOULD NOT BE INTERPRETED TO BE EXACT LOCATION NOR SHOULD IT BE ASSUMED THAT THEY

ARE THE ONLY UTILITIES IN THE AREA. FIELD WORK PERFORMED BY: HURLEY & STEWART, LLC


8/13/24

Sheet

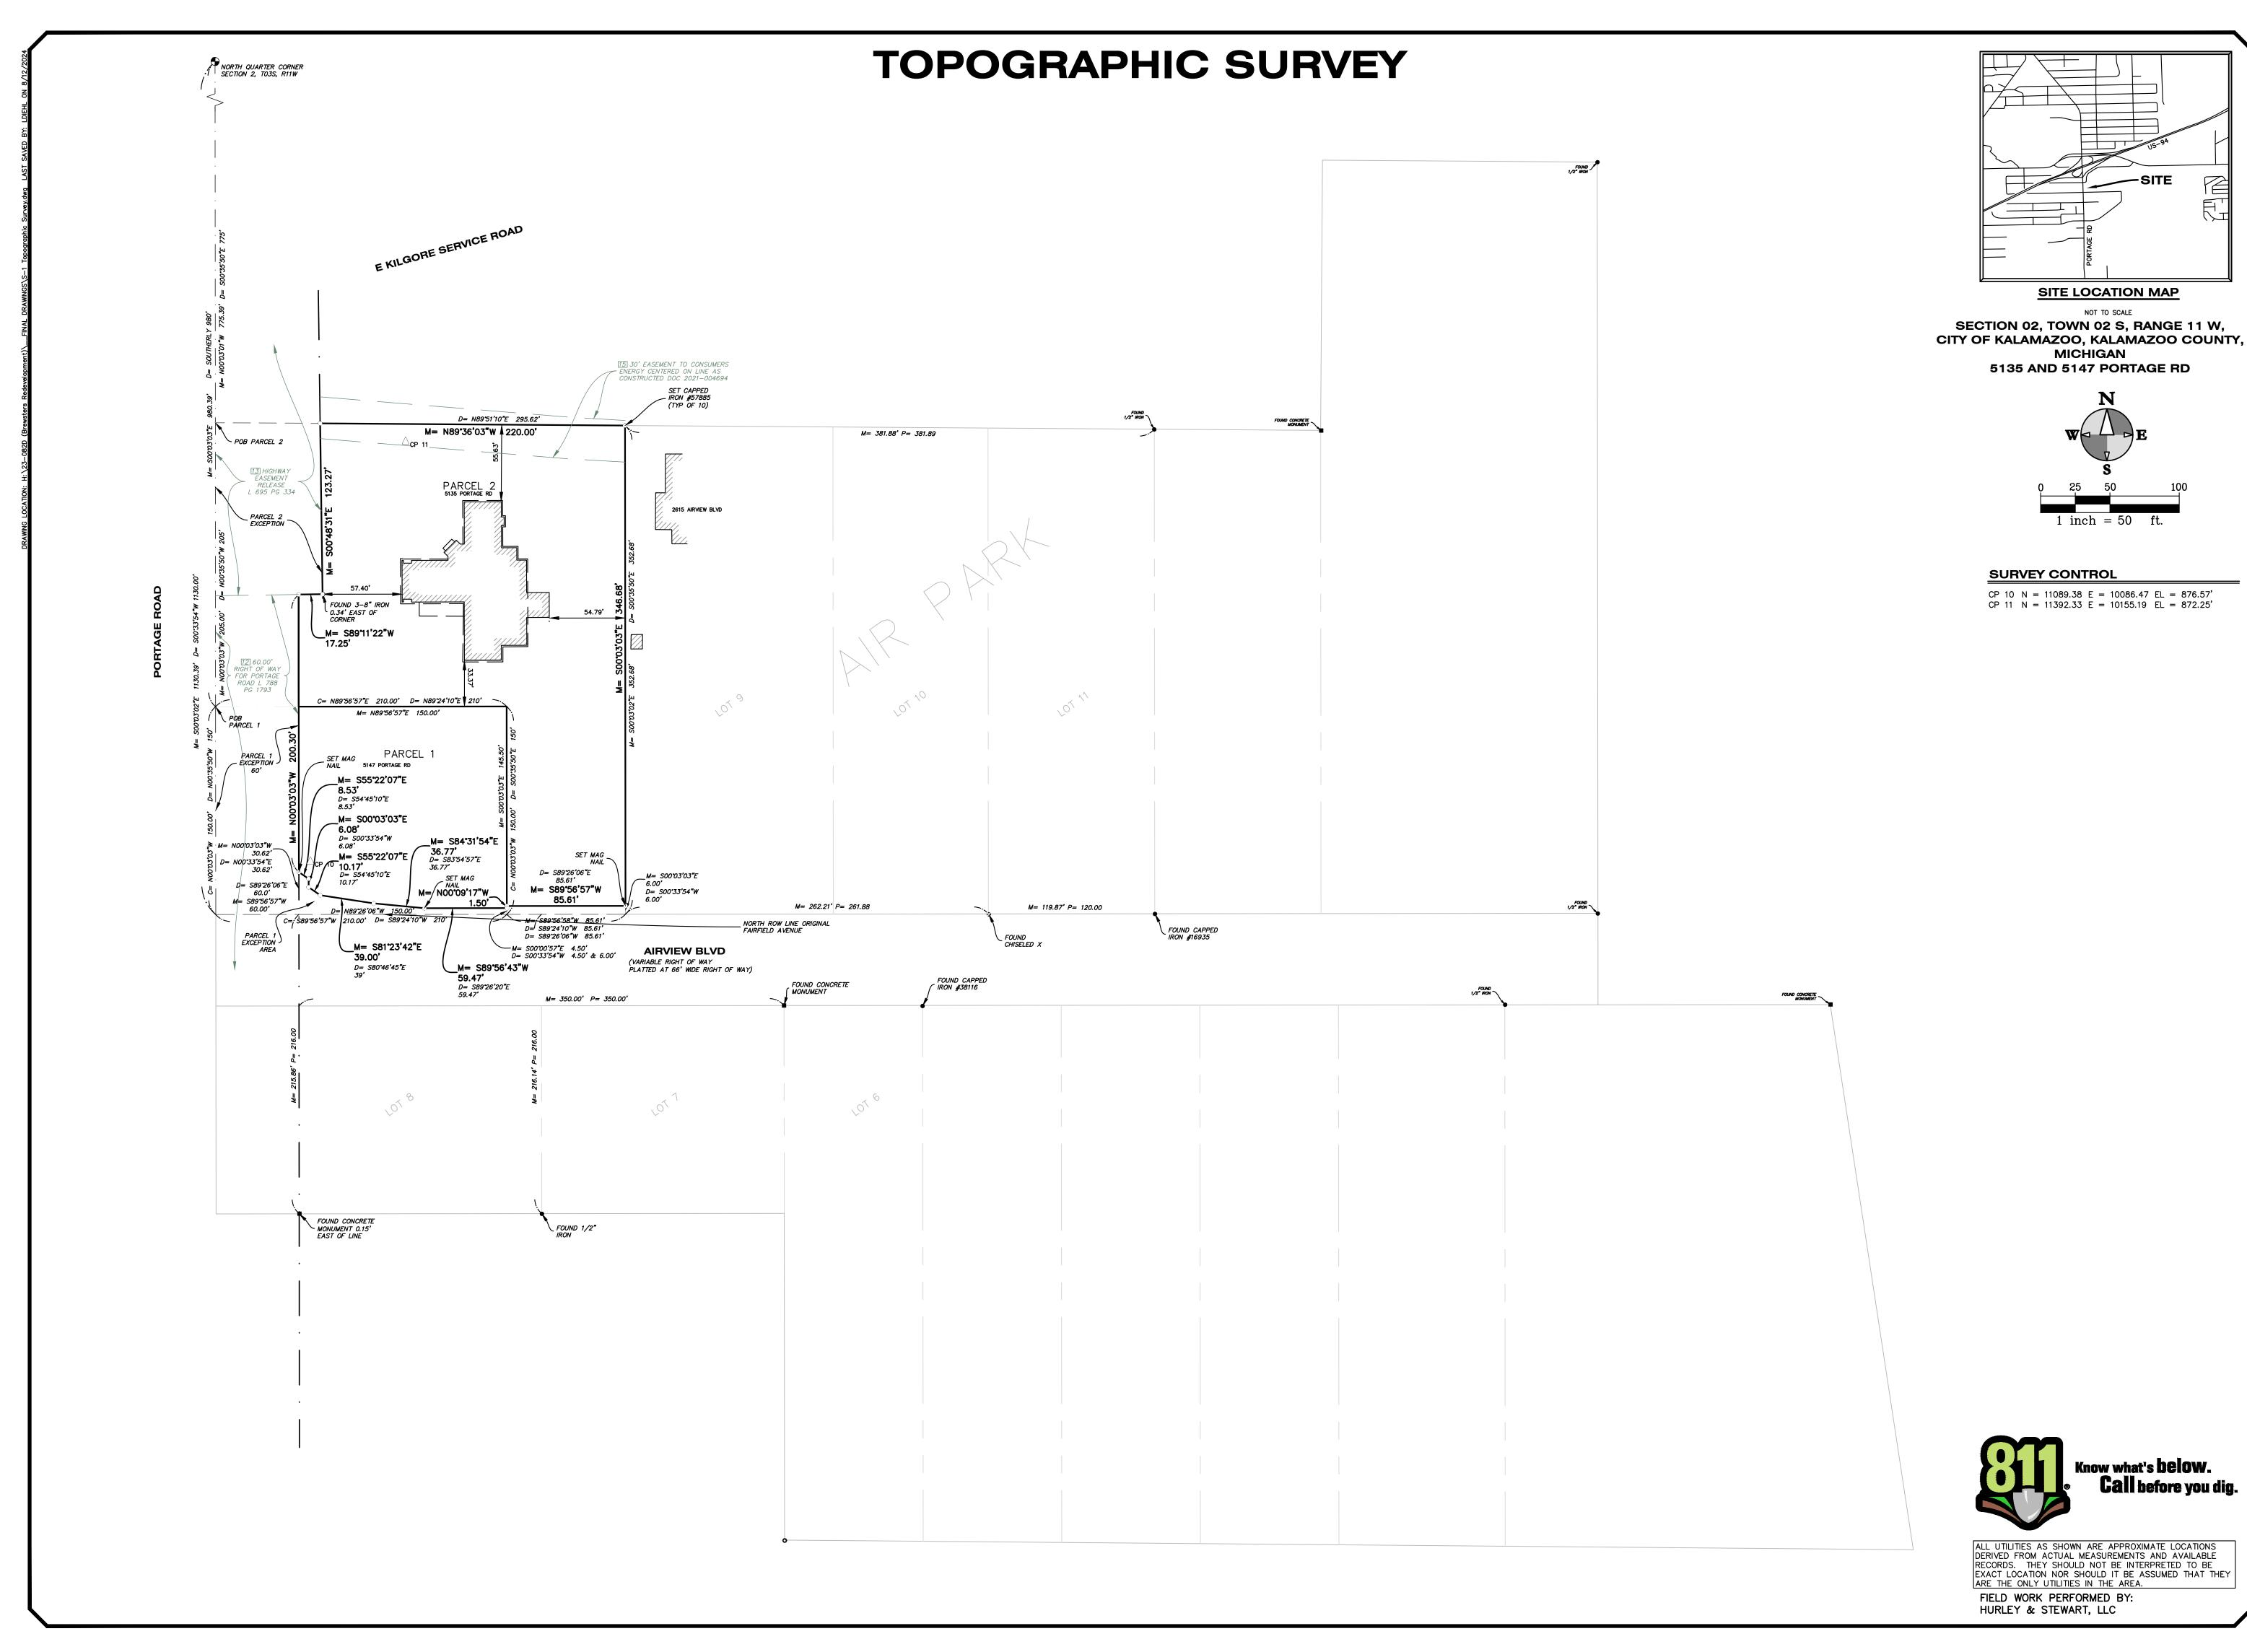

TOPOG

8/13/24

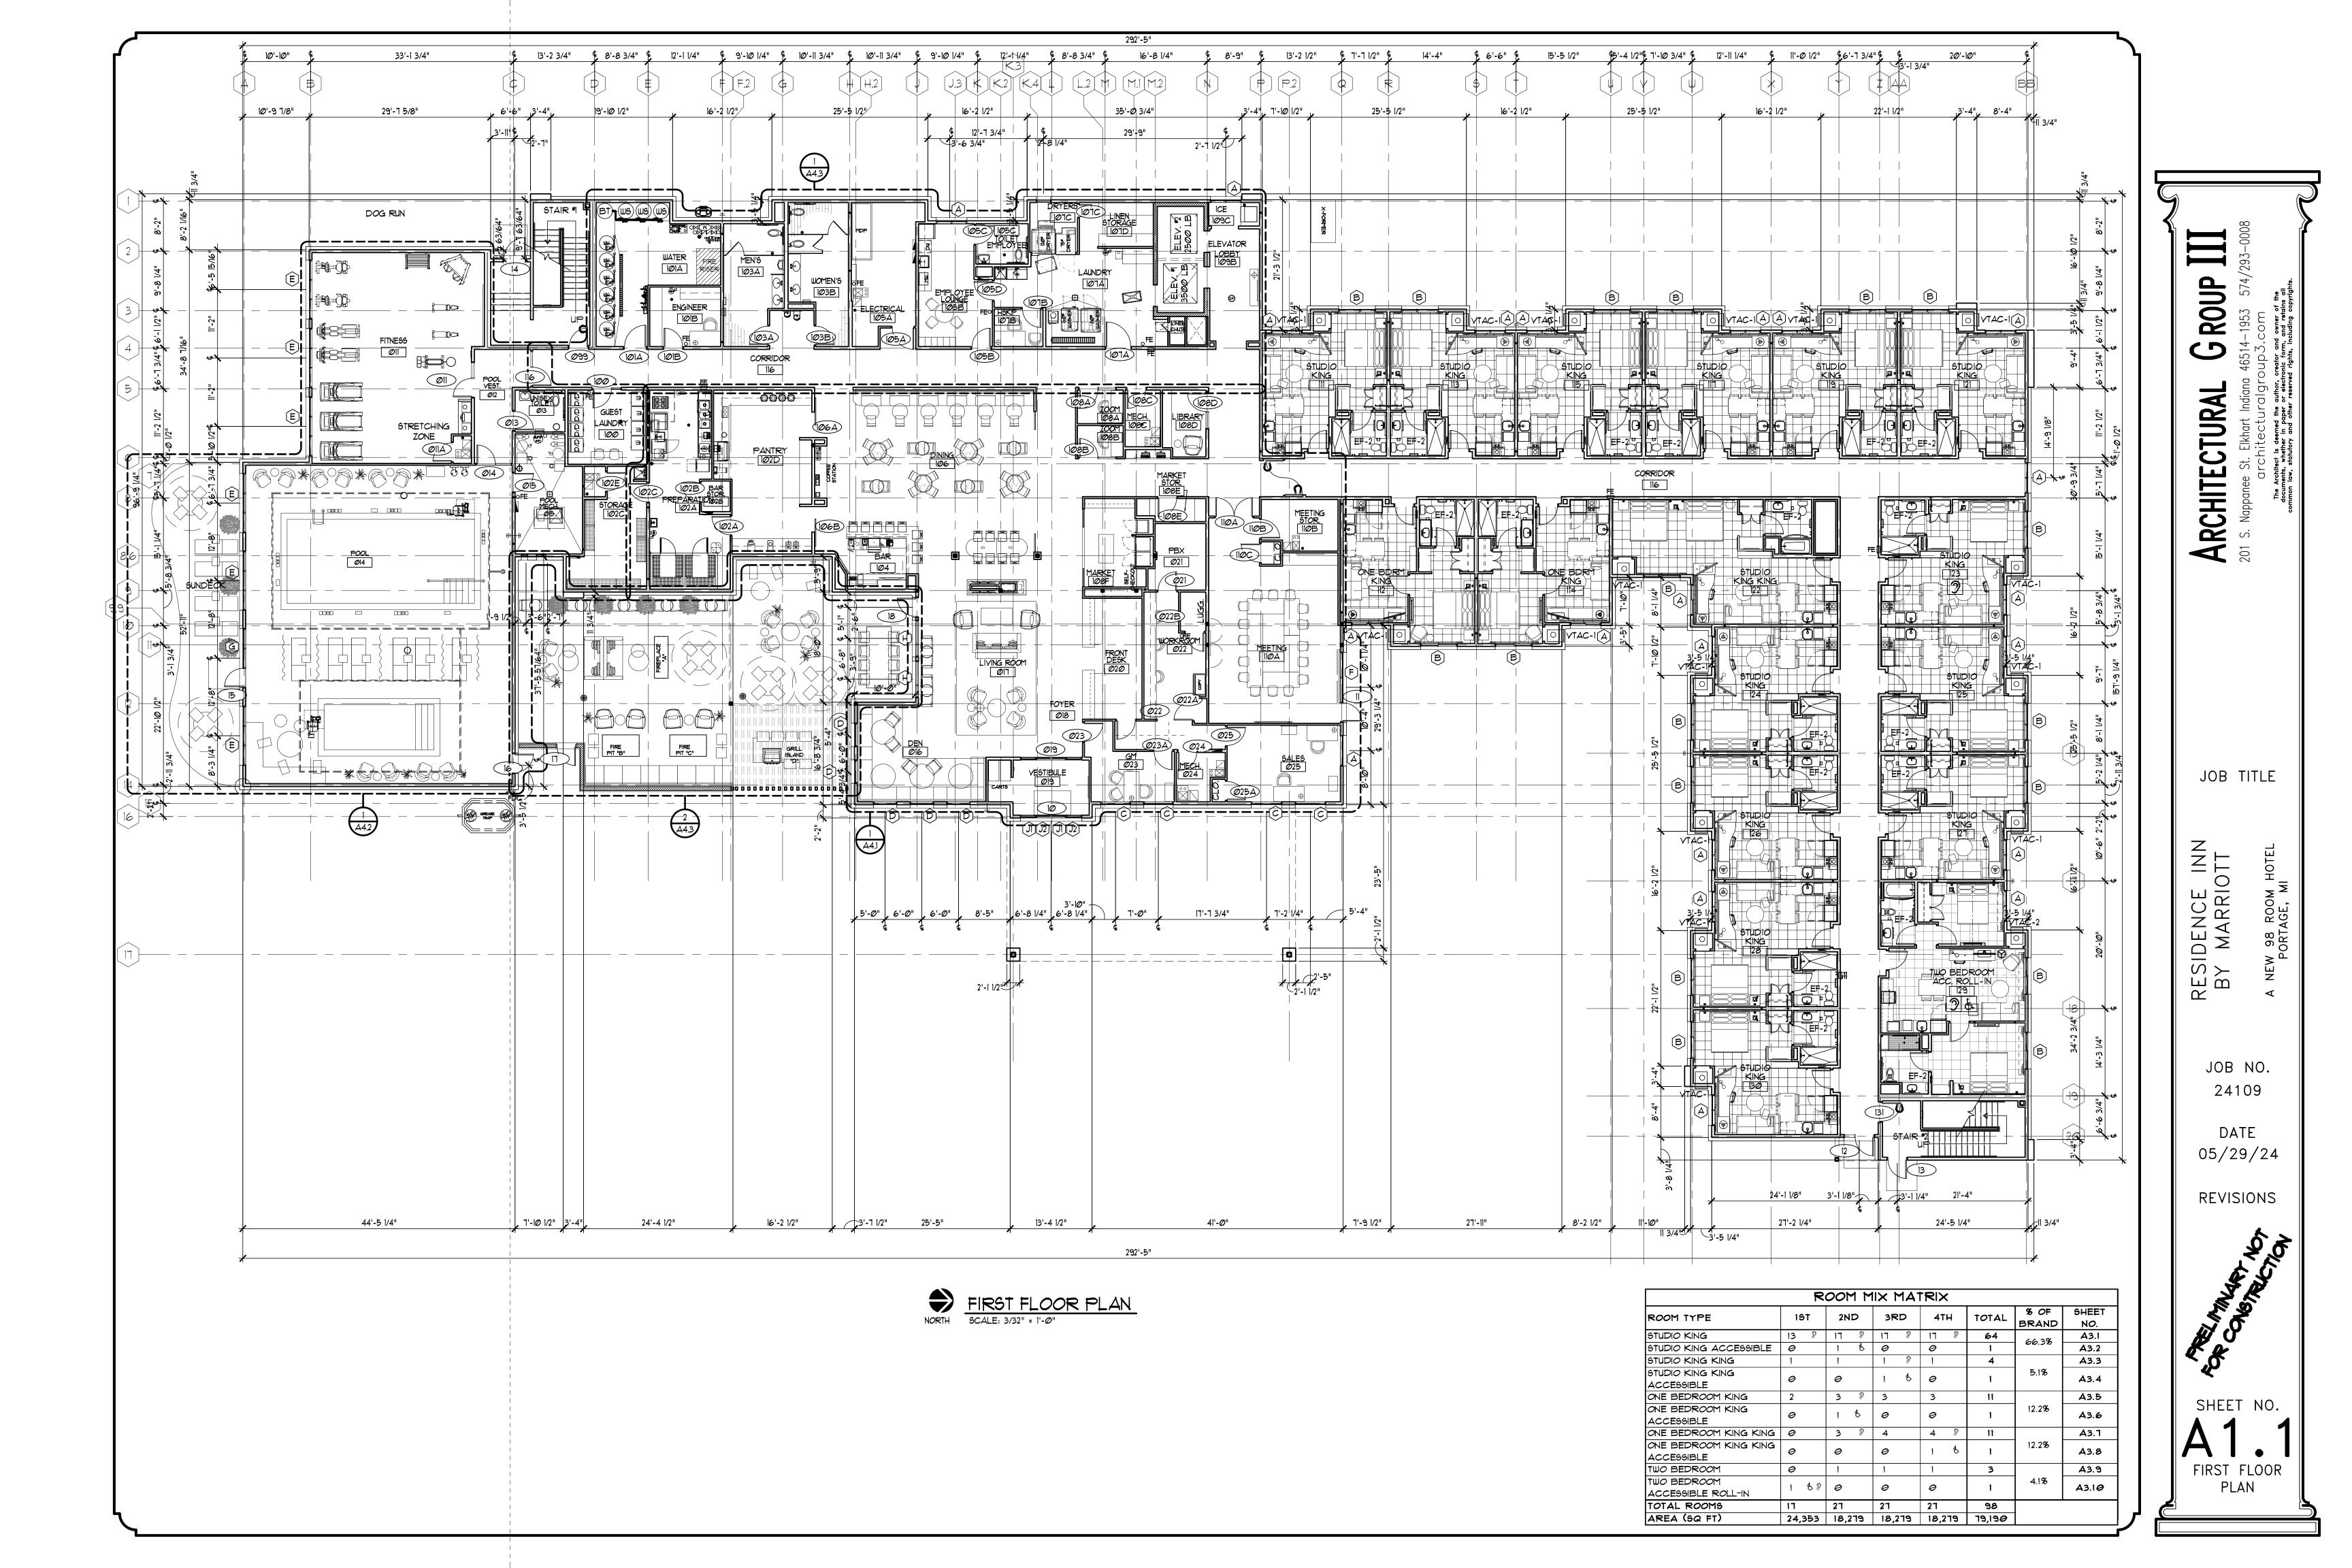



WEST ELEVATION
SCALE: 3/32" = 1'-0"



SOUTH ELEVATION


SCALE: 3/32" = 1'-0"


MATERIAL KEY: BRICK VENEER COLOR: EFIS COLOR: **CHATEAU BROWN (BUTBLE)** WOOD COLOR: **JAVA (CINGRA)** CONCRETE NOTE: ALL COPINGS AND GRAVEL STOPS TO MATCH ADJACENT WALL/TRIM COLOR

G ROUP ARCHITECTURAL 201 S. Nappanee St. Elkhart Indiana JOB TITLE RESIDENCE INN BY MARRIOTT NEW 98 ROOM HOTEL PORTAGE, MI JOB NO. 24109 DATE 05/29/24

REVISIONS

SHEET NO. MASSING **ELEVATIONS**

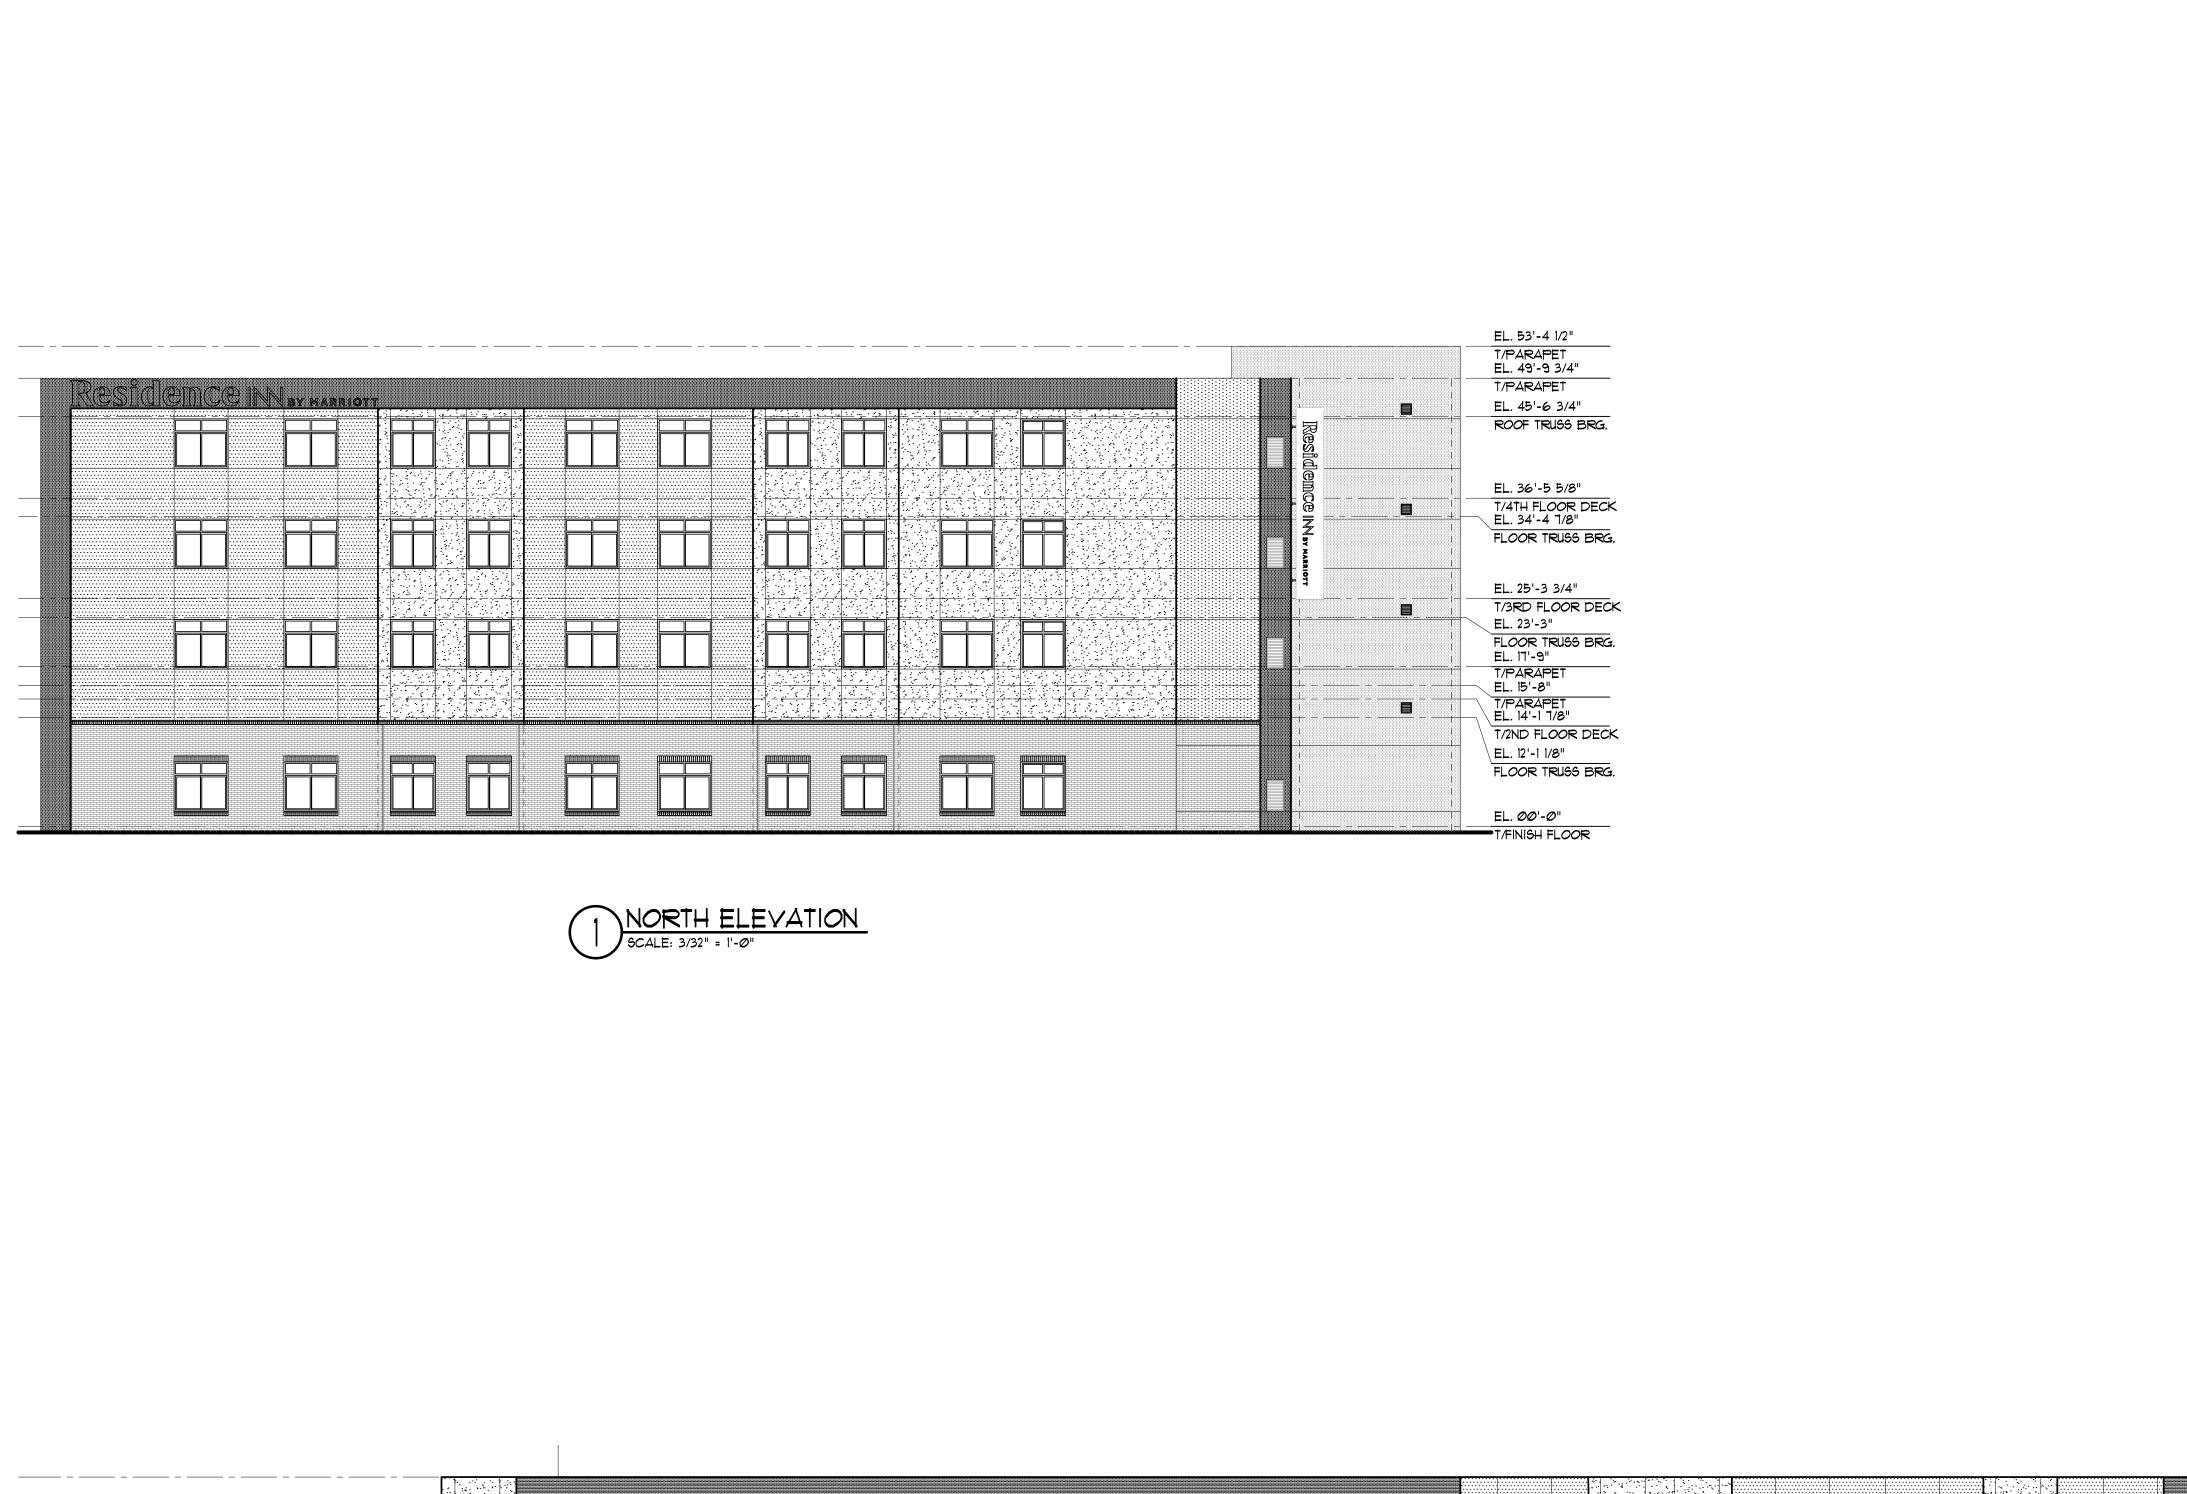

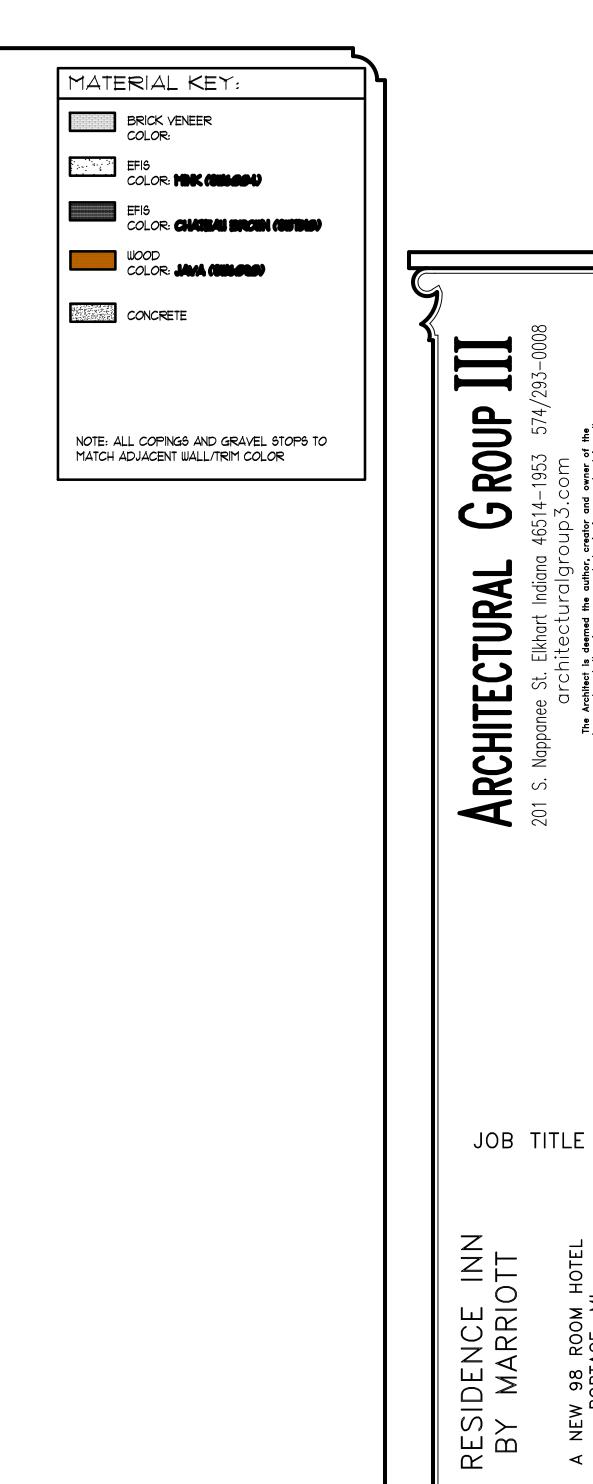

E. 49-9 M*

174-9 M*

18. 49-9 M*

18. 49-9 M*

18. 49-9 M*

19. 49-9

2 EAST ELEVATION 9CALE: 3/32" = 1'-@" REVISIONS

SHEET NO.

JOB NO.


24109

DATE

05/29/24

A2.2


MASSING
ELEVATIONS

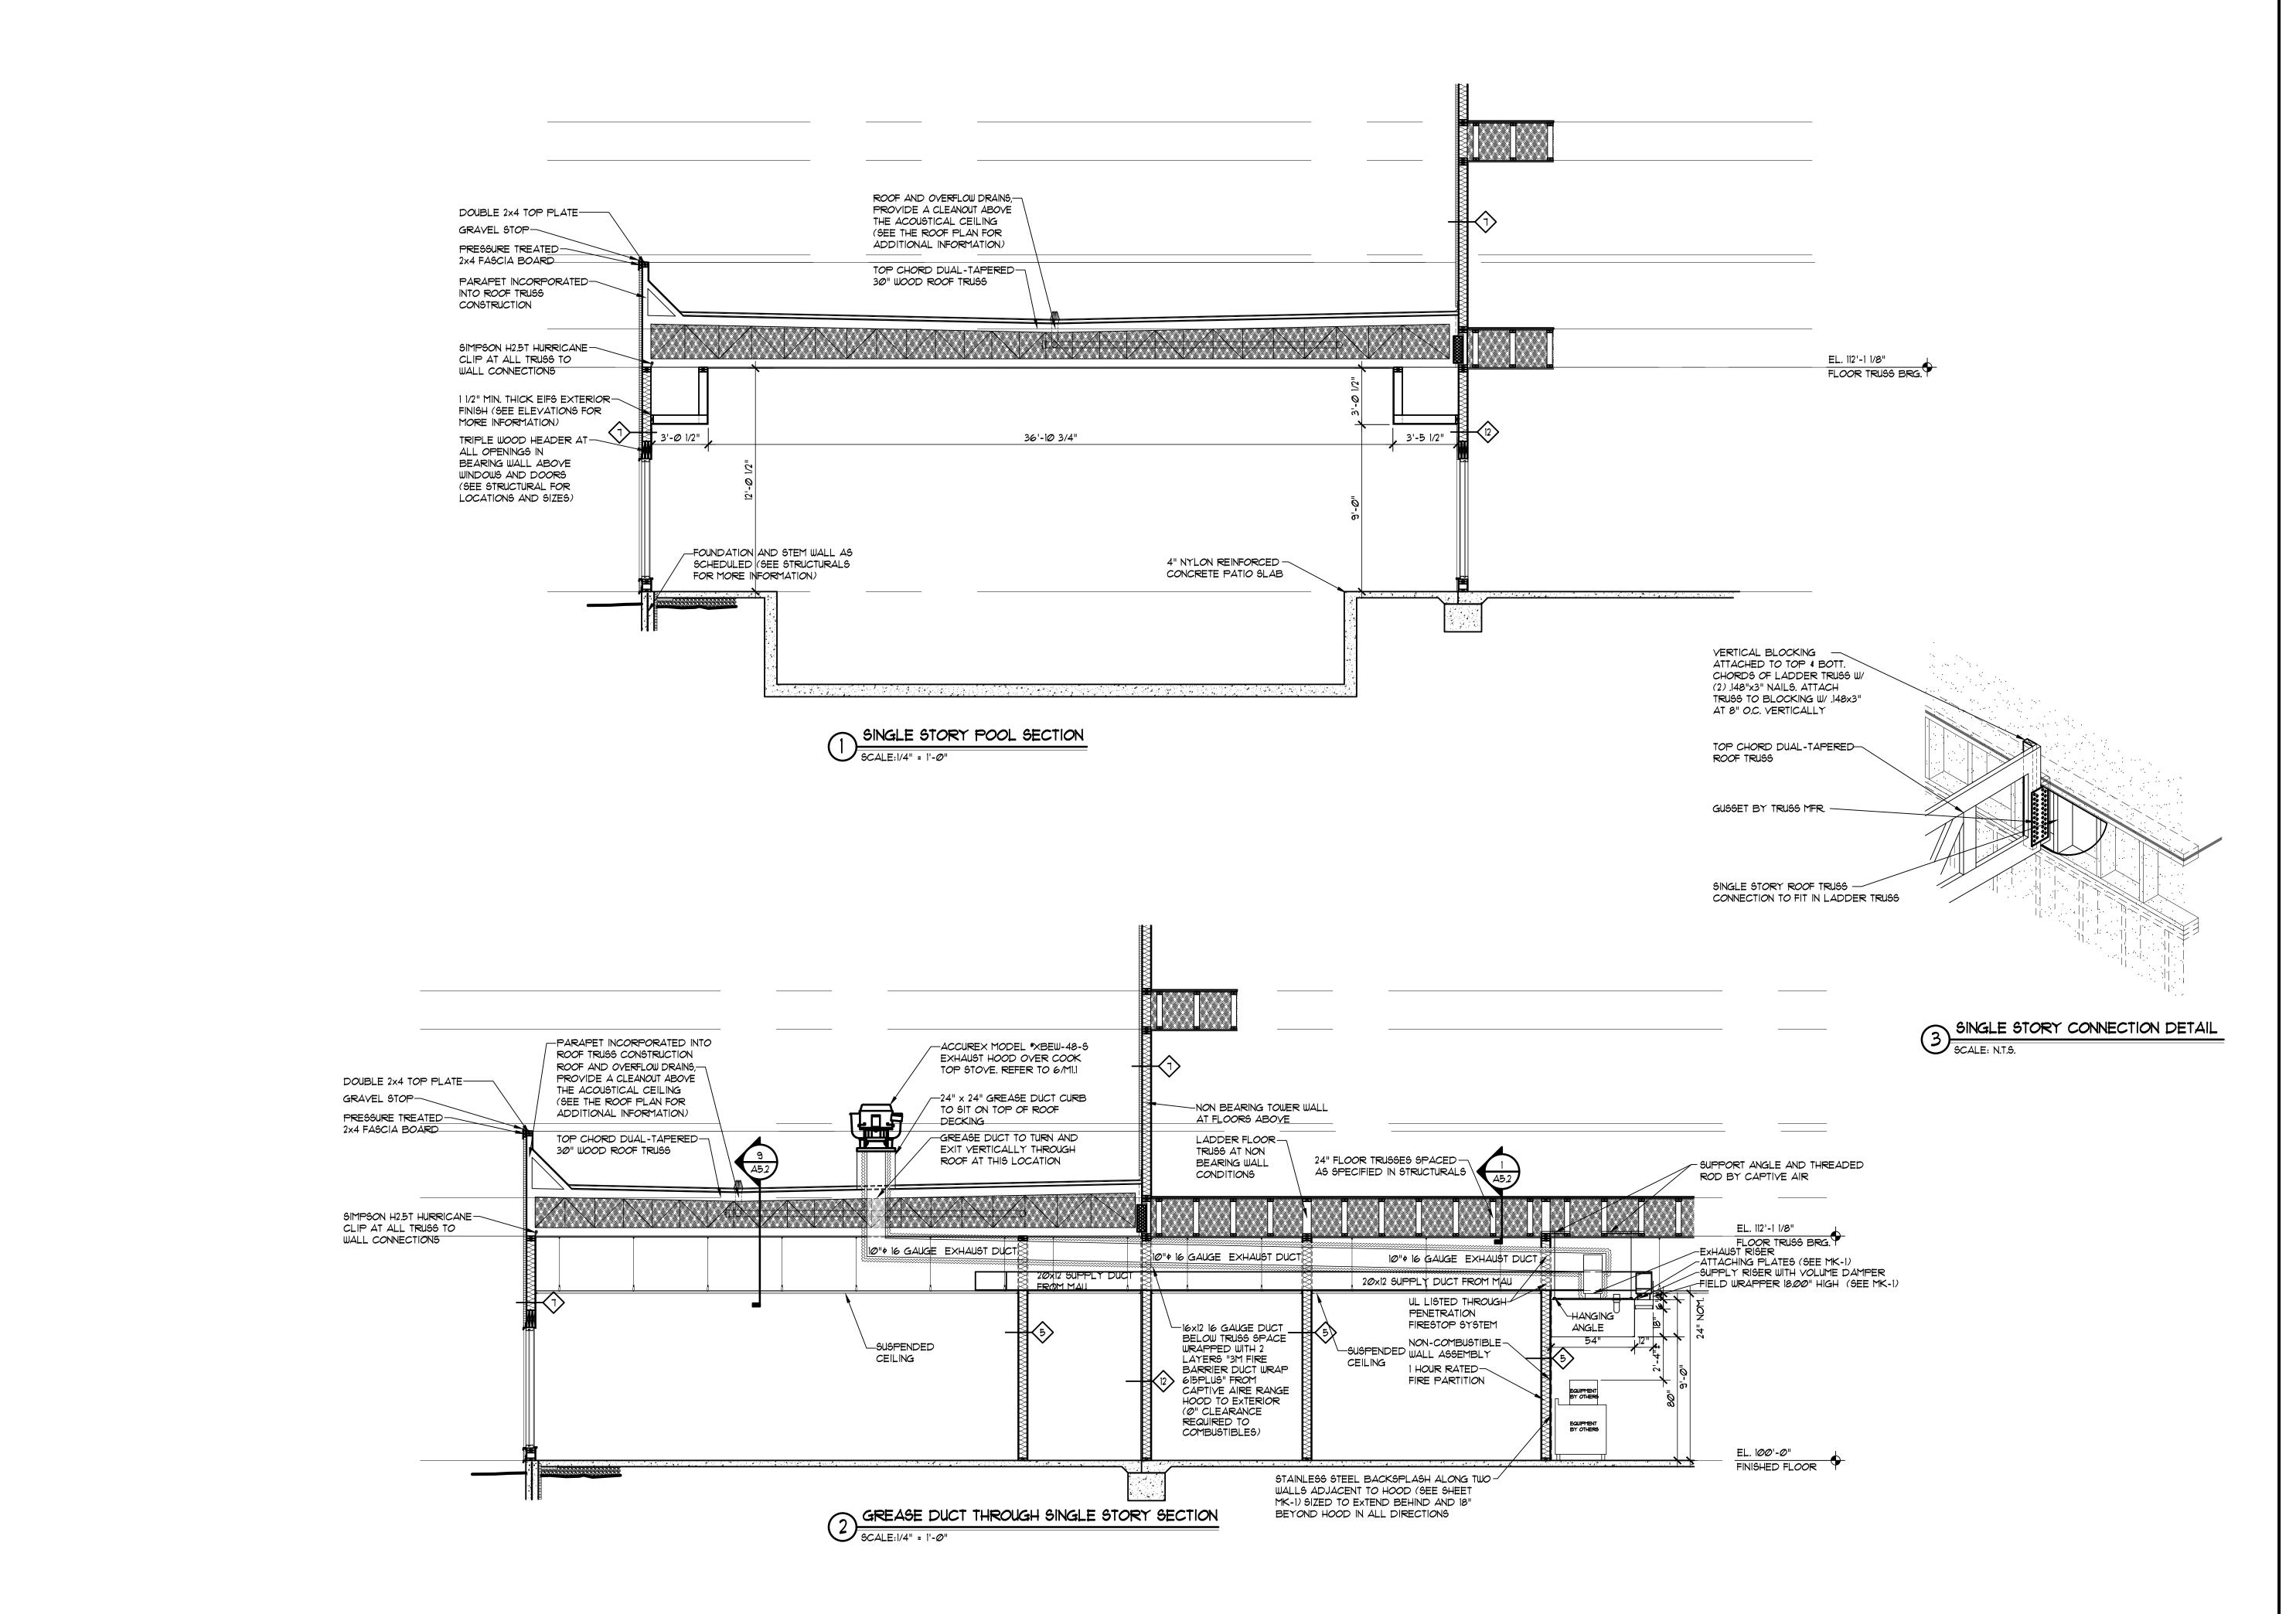

ROUP ARCHITECTURAL 201 S. Nappanee St. Elkhart Indiana JOB TITLE RESIDENCE INN BY MARRIOTT JOB NO. 24109 DATE 05/29/24 REVISIONS

SHEET NO.

SINGLE STORY SECTIONS

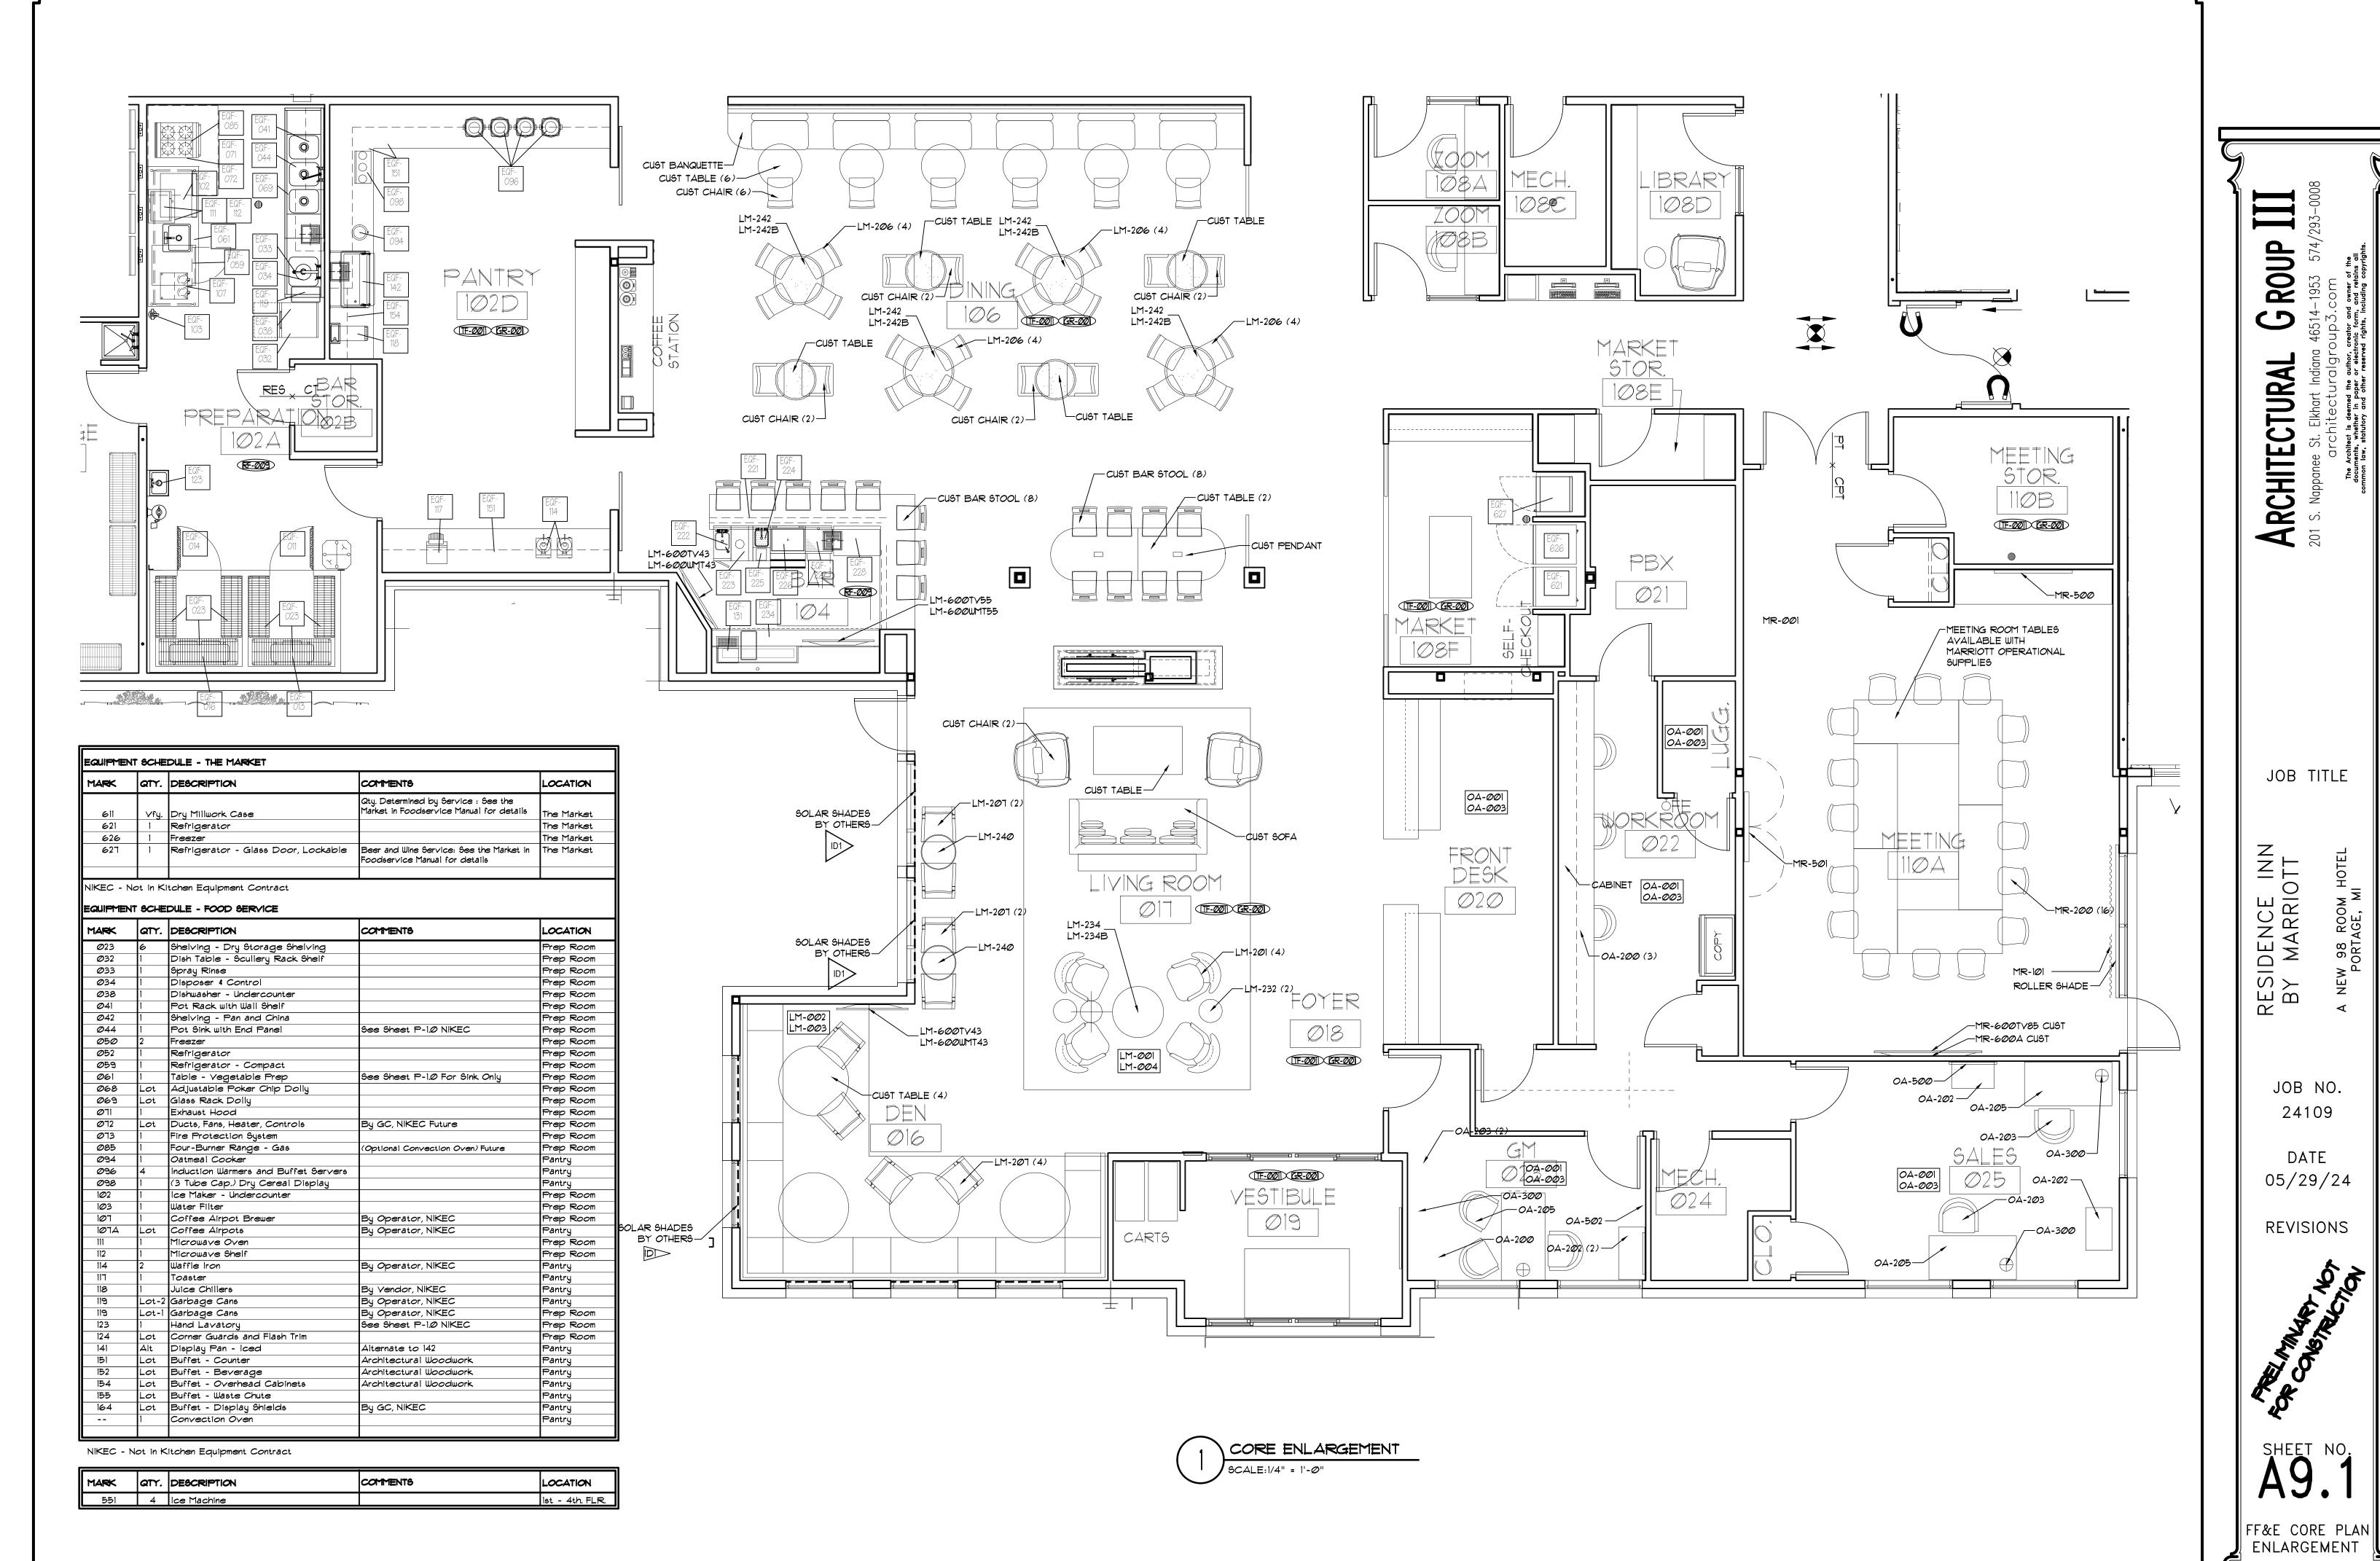

		PLUMBING FIXTURE SCHEDULE				
CALL DUT	FIXTURE TYPE	ACCESSORIES	MODEL NUMBER	FINISH	MANUFACTURER	PROTOTYPE CALL OUT
PI	TANK TOILET - GUEST	"CADET PRO ELONGATED TOILET" 128 GPF (WATERSENSE CERTIFIED) ELONGATED SEAT, CLOSED FRONT WITH COVER. 'STA-TITE" FASTENING SYSTEM	MDL *215CA.104.020 MDL *1900TDGSL WATER SUPPLY STOP TO BE MOUNTED 10" AFF.	WHITE WHITE	AMERICAN STANDARD BEMIS	WCL-Ø1
P2	ADA TANK TOILET - GUEST	"CADET PRO RIGHT HEIGHT ELONGATED TOILET" 1.28 GPF (WATER SENSE CERTIFIED) RIGHT HAND FLUSH TOILET WITH CONCEALED TRAP	MDL *215AA.104.020 WATER SUPPLY STOP TO BE MOUNTED 10" A.F.F.	WHITE	AMERICAN STANDARD AMERICAN STANDARD	WCL-@3
P3	FLUSHOMETER TOILET	ELONGATED SEAT, CLOSED FRONT WITH COVER. 'STA-TITE" FASTENING SYSTEM "MADERA ELONGATED FLUSH VALVE TOILET" 1.10 TO 1.60 GPF ELONGATED SEAT, OPEN FRONT W/ NO COVER. "JUST-LIFT" INTEGRATED HINGE SYSTEM, "STA-TITE FASTENING SYSTEM	MDL #1900TDGSL MDL #2234.001.020 MDL #2155CTJ	WHITE WHITE WHITE	BEMIS AMERICAN STANDARD CHURCH, A DIVISION OF BEMIS	WCL-05
P4	ADA FLUSHOMETER TOILET	"MADERA ADA ELONGATED FLUSH VALVE TOILET"	MDL #61479M161.002 MDL #2234.001.020 MDL #2155CTJ	WHITE	AMERICAN STANDARD AMERICAN STANDARD	WCL-06
		ELONGATED SEAT, OPEN FRONT W/ NO COVER. "JUST-LIFT" INTEGRATED HINGE SYSTEM, "STA-TITE FASTENING SYSTEM EXPOSED FLUSH VALVE - ELECTRONIC OPERATION	MDL *61479M161.002	WHITE CHROME	CHURCH, A DIVISION OF BEMIS AMERICAN STANDARD	
P5	ADA URINAL	WASHBROOK URINAL FLUSHOMETER	MDL *6590.001.020 MDL *6063013.002	WHITE CHROME	AMERICAN STANDARD AMERICAN STANDARD	URN-01
P6	COUNTER TOP LAVATORY GUEST	FAUCET	MDL #0614.000.020 MDL #561-MPU-DST	WHITE CHROME	AMERICAN STANDARD DELTA	SINK-25
PT	ADA COUNTER TOP LAYATORY GUEST	STUDIO UNDERCOUNTER LAVATORY	MDL #K-8998 MDL #0614.000.020 MDL #561-MPU-DST	CHROME WHITE CHROME	KOHLER AMERICAN STANDARD DELTA	SINK-25
P8	WALL HUNG LAVATORY EMPLOYEE	LUCERNE WALL-MOUNT SINK NEXTGEN SELECTRONIC INTEGRATED TOUCHLESS LAVATORY FAUCET	MDL #0355.012.020 MDL #175B.103	CHROME CHROME	AMERICAN STANDARD AMERICAN STANDARD	SINK-Ø3
		TOUCHLESS LAVATORY FAUCET POWER SUPPLY LAVATORY GRID DRAIN WITH OVERFLOW	MDL *PKØ1-HAC MDL *2411.015	CHROME CHROME	AMERICAN STANDARD AMERICAN STANDARD	
P9	COUNTER TOP LAVATORY PUBLIC	OVALYN UNDER-MOUNT LAVATORY NEXTGEN SELECTRONIC INTEGRATED TOUCHLESS LAVATORY FAUCET	MDL #0496.221.020 MDL #175B.103	CHROME CHROME	AMERICAN STANDARD AMERICAN STANDARD	SINK-Ø4
			MDL #PKØ1-HAC MDL #2411.015	CHROME CHROME	AMERICAN STANDARD AMERICAN STANDARD	
PIØ	TUB / SHOWER SHOWER HEAD MOUNTED 6'-10" AFF.	PRINCETON RECESS BATH MINCEY MARBLE SHOWER SURROUND (CAST POLYMER) "COMPEL" SERIES TUB/SHOWER TRIM W/ SHOWER ARM AND FLANGE FOR FIXED SHOWER HEAD W/ RED/BLUE INDEX W/ DIVERTER TUB SPOUT AND PRESSURE BALANCE VALVE / LESS SHOWERHEAD	MDL *2391.202.020 R MDL *K2390.202.020 L REFER INTERIOR FINISH INDEX 06 61 13 MDL *T14661-LHD & R10000-UNWS DRAIN MDL *90410	WHITE WHITE CHROME CHROME	AMERICAN STANDARD MINCEY MARBLE DELTA MOEN	TUB-06
PII	ADA TUB / SHOWER	H2O KINETIC TECHNOLOGY TOUCH CLEAN MULTIFUNCTION SHOWER HEAD PRINCETON RECESS BATH	MDL #52638-20-PK MDL #2391.202.020 R MDL #K2390.202.020 L	CHROME WHITE	DELTA AMERICAN STANDARD	TUB-Ø1
	SHOWER HEAD MOUNTED 6'-10" AFF.	MINCEY MARBLE SHOWER SURROUND (CAST POLYMER) "COMPEL" SERIES TUB/SHOWER TRIM W/ SHOWER ARM AND FLANGE FOR FIXED SHOWER HEAD W/ RED/BLUE INDEX AND PRESSURE BALANCE VALVE / LESS SHOWERHEAD H20 KINETIC TECHNOLOGY TOUCH CLEAN MULTIFUNCTION SHOWER HEAD	REFER INTERIOR FINISH INDEX 06 61 13 MDL *T14661-LHD & R10000-UNWS & 50560 DRAIN MDL *30410 MDL *59445-PK HAND HELD	WHITE CHROME	MINCEY MARBLE DELTA DELTA	
		BREAKER FOR HAND HELD SHOWER HEAD (BY TRIM MANUFACTURER)(5-SETTINGS)	MDL #52638-20-PK MDL #TII861 & RII000	CHROME	DELTA	
P12	SHOWER	HANDHELD SHOWER HEAD 60" X 34" SINGLE-THRESHOLD SHOWER BASE	MDL *CFP-TD-3460-05/SF(L OR = R)	WHITE	KOHLER MINCEY MARBLE	6HR-11
	SHOWER HEAD MOUNTED 6'-10" AFF.	MINCEY MARBLE, CUSTOM SHOWER SURROUND WITH SOAP DISH. H2O KINETIC TECHNOLOGY TOUCH CLEAN MULTIFUNCTION SHOWER HEAD "COMPEL" SERIES SHOWER TRIM W/ SHOWER ARM AND FLANGE FOR FIXED SHOWER HEAD W/ RED/BLUE	CONTACT: DONNA MINCEY, (770) 532-045 MDL #52638-20-PK MDL #T14261-LHD & RI0000-UNWS	WHITE CHROME CHROME	MINCEY MARBLE DELTA DELTA	
		INDEX WITH PRESSURE BALANCE VALVE / LESS SHOWERHEAD DRAIN COVER FOR 60" X 34" SHOWER BASE	MDL #K-9132-CP	CHROME	KOHLER	
PI3	ADA SHOWER	ENTIRE ADA ROLL-IN SHOWER TO BE TILED H2O KINETIC TECHNOLOGY TOUCH CLEAN MULTIFUNCTION SHOWER HEAD "COMPEL" SERIES TUB/SHOWER TRIM W/ SHOWER ARM AND FLANGE FOR FIXED SHOWER HEAD W/ RED/BLUE	MDL #52638-20-PK	CLIDOME	BY OWNER DELTA DELTA	SHR-13
	SHOWER HEAD MOUNTED 6'-10" AFF.	"COMPEL" SERIES TUB/SHOWER TRIM W/ SHOWER ARM AND FLANGE FOR FIXED SHOWER HEAD W/ RED/BLUE INDEX W/ PRESSURE BALANCE VALVE / LESS SHOWERHEAD "PERSONAL HAND HELD SHOWER" / SUPPLY ELBOW / 60" METAL SHOWER HOSE. PROVIDE IN-LINE VACUUM BREAKER FOR HAND HELD SHOWER HEAD (BY TRIM MANUFACTURER/S-SETTINGS) "COMPEL" SERIES 3-FUNCTION DIVERTER TRIM WITH DIVERTER ROUGH VALVE BODY FOR FIXED TO	MDL #T14261-LHD & RIOOOOO-UNWS MDL #59445-PK HAND HELD	CHROME CHROME	DELTA	
		HANDHELD SHOWER HEAD SHOWER SEAT- NYLON COATED - WALL MOUNTED	MDL *KT11861 & R11000 MDL *OATEY DRAIN	CHROME	DELTA OATEY	5NK-29
P14	GUEST ROOM BAR SINK KITCHEN	UNDRETONE UNDERMOUNT KITCHEN SINK CONTEMPORARY BAR SINK FAUCET GARBAGE DISPOSAL	MDL #K-3336 MDL #1959LF MDL #GFC325N	STAINLESS STEEL CHROME	KOHLER DELTA GE	5NK-29
P15	WASHER BOX	QUADTRO WASHING MACHINE OUTLET BOX	MDL #3853Ø	WHITE	OATEY	
P16	EMPLOYEE BREAKROOM SINK		MDL #LRAD2521 × 5-1/2 DEEP	STAINLESS STEEL	ELKAY	SNK-13
PIT	PREP SINK	FOUNDATION SERIES SINGLE-HANDLE DECK MOUNT FAUCET W/ SIDESPRAY AND LEVER HANDLE W/ RED/BLUE INDEX GARBAGE DISPOSAL ADVANCE TABCO WELDED SINK	MDL #B4410LF MDL *GFC325N MDL TA-11J	CHROME STAINLESS STEEL	DELTA GE ADVANCE TABCO	
PIS	HAND WASH SINK	TINKEY KITCHEN SINK FAUCET WITH SPRAY	MDL #1408400.15 MDL #1-P5-80	STAINLESS STEEL	AMERICAN STANDARD ADVANCA TABCO	
Dio.		STEEL, WITH SPLASH MOUNTED FAUCET W/ WRIST BLADE HANDLES, SOAP DISPENSOR, LEVER DRAIN W/ OVERFLOW AND P-TRAP, WALL BRACKET, NSF 1 10' TRENCH DRAIN KIT COMPLETE		CHROME	KOHLER	
P19 P2Ø	LAUNDRY SINK	40" UTILATWIN LAUNDRY TUB	MDL *2806-Z-U6-RFGC-DB MDL *27FX18.300F	WHITE	ZURN MUSTEE	\$√\$- <i>Ø</i> 2
P21	MOP SINK	MOP SERVICE BASIN-1 PIECE, MOLDED FIBERGLASS CONSTRUCTION INTEGRALLY MOLDED	MDL #2133 MDL #63M	CHROME WHITE	DELTA MUSTEE	MOP-ØI
		CENTER DRAIN WITH SEAL EXPOSED YOKE WALL MOUNT UTILITY FAUCET WITH TOP BRACE AND VACUUM BREAKER HEAVY DUTY 5/8" DIAMETER, 31" RUBBER HOSE	MDL #29T9	CHROME	DELTA	
		SPRING LOADED MOLDED RUBBER HOSE HOLDER ON STAINLESS STEEL WALL PLATE 12" HIGH 20 GAUGE *304 STAINLESS STEEL WALL GUARD / WALL MOUNTED	MDL *65.700 MDL *67.2424	STAINLESS STEEL STAINLESS STEEL	E.L. MUSTEE & SONS E.L. MUSTEE & SONS	
P22	TRIPLE SINK	MOP HANGER THREE COMPARTMENT SINK WITH DISPOSER CONE AND	MDL *63.600 MDL *93-3-120-48LI8R	STAINLESS STEEL STAINLESS STEEL	E.L. MUSTEE & SONS ADVANCE TABCO	
,		ISE SS-200 DISPOSER (1) BACKSPLASH MOUNTED PRE-RINSE FAUCET WITH WALL BRACKET AND 8" CENTERS - 12" SWING, SPOUT (1) WALL MOUNTED FAUCET WITH 8" CENTERS, 12" SWING, NOZZLE, 2.2 GPM AERATOR, AND LEVER HANDLES. 1,000 GALLON EXTERIOR GREASE TRAP	MDL #22-200 MDL #48917 MDL #3253	CHROME CHROME CHROME	INSINKERATOR FISHER FISHER	
	URN TROUGH	12" DROP IN TROUGH	MDL #TA521	STAINLESS STEEL	ADVANCE TABCO	
	3" FLOOR SINK	3" PIPE FIT - COMPLETE FLOOR SINK KIT - 1/2 TOP GRATE - FLAT BOTTOM GRATE PVC	MDL #559-063	WHITE PROMITE	JONES STEPHENS	
	3" FLOOR DRAIN 4" FLOOR DRAIN	CLAMP, & P-TRAP OR APPROVED EQUAL W/ TRAP PRIMER CAST IRON W/ POLISHED BRONZE ADJUST STRAINER, (2)-PIECE BODY FLASHING COLLAR	MDL *Z415B MDL *Z415B	POLISHED BRONZE POLISHED BRONZE	ZURN	
P27	POINT OF USE INLINE WATER FILTER	CLAMP, & P-TRAP OR APPROVED EQUAL W/ TRAP PRIMER DESIGNED FOR USE WITH ICE MAKERS, SINGLE WATER FILTER, WITH SPECIAL SCALE INHIBITOR			ICE-O-MATIC	
P28	BOTTLE FILLING STATION	HYDRATION STATION WITH LIFECYCLE	MDL #2 <i>000</i> \$N	POLISCHOME & WHITE	наше	
		COMMERCIAL CLOTH WASHERS	PROVIDED BY OWNER CPZ886-06		- N. W. S.	
		TRENCH DRAIN K BI-LEVEL NON-REFRIGERATED DRINKING FOUNTAIN NARROW WALL HYDRANT	MDL #HRF-SEBP	POLISHED BRONZE WHITE	ZURN HALSEY TAYLOR	
	WALL HYDRANT	NARROW WALL HYDRANT HYDRANT WITH A 16" WALL THICKNESS KOHLER ARTIFACTS RITE-TEMP PRESSURE BALANCED SHOWER SYSTEM	MDL #ZI349 MDL #ZI320 MDL #K-ARTIFACT6-RTII-4-CP	CHROME	ZURN ZURN KOHLER	
	POOL SHOWER EMERGENCY EYE WASH	WITH SHOWER HEAD AND HAND SHOWER SPEAKMAN WALL MOUNTED EMERGENCY EYEWASH WITH	MDL *6E-582	CHROTE	SPEAKMAN	
P33		THERMOSTATIC MIXING VALVE	MDL *92ØIEFE		HAWS	
P33	WATER FILTER	TRIPLE CLEAR FORCE FIELD	MDL #EV-9324-61		IEVER PURF	
P33 P34 P35 P36	WATER FILTER AREA DRAIN YARD HYDRANT	12" ROUND AREA DRAIN NON-FREEZE WALL HYDRANT W/"T" HANDLE KEY	MDL #EV-9324-61 MDL #Z541 Y34 WITH BACKFLOW PREVENTER	RED / GALVANIZED	EVER PURE ZURN WOODFORD	
P33 P34 P35	AREA DRAIN	12" ROUND AREA DRAIN	MDL #Z541	RED / GALVANIZED	ZURN	

COUNT	TYPE	FIXTURE	DRAINAGE FI	XTURE UNITS		WATE	R SUPPLY FIXTURE	UNITS	
			EA	TOTAL	COLD	НОТ	TOTAL HOT	EA	
97	P1	TANK TOILET	3	291	2.2	0.0	0.0	2.2	T
5	P2	ADA TANK TOILET	3	15	2.2	0.0	0.0	2.2	
1	P3	FLUSH VALVE TOILET	4	4	10.0	0.0	0.0	10.0	Т
4	P4	ADA FLUSH VALVE TOILET	4	16	10.0	0.0	0.0	10.0	T
1	P5	ADA URINAL	2	2	5.0	0.0	0.0	5.0	T
97	P6	COUNTERTOP LAV - GUEST ROOM	1	97	0.5	0.5	50.9	0.7	
5	P7	ADA COUNTERTOP LAV GUEST ROOM	1	5	0.5	0.5	2.6	0.7	
2	P8	WALL HUNG LAV	1	2	0.5	0.5	1.0	0.7	
4	P9	COUNTER TOP LAV PUBLIC	1	4	1.5	1.5	6.0	2.0	
19	P10	TUB/SHOWER	2	38	1.0	1.0	19.0	1.4	
4	P11	HC TUB/SHOWER	2	8	1.0	1.0	4.0	1.4	
78	P12	SHOWER	2	156	1.0	1.0	78.0	1.4	
1	P13	H.C. SHOWER	2	2	1.0	1.0	1.0	1.4	
98	P14	GUEST RM BAR SINK	2	196	1.0	1.0	98.0	1.4	
4	P15	WASHER BOX	3	12	3.0	3.0	12.0	4.0	Т
1	P16	EMPLOYEE BREAKROOM SINK.	2	2	1.0	1.0	1.0	2.0	
1	P17	PREP SINK.	2	2	1.0	1.0	1.0	2.0	
1	P18	HAND WASH SINK	1	1	1.5	1.5	1.5	2.0	Τ
1	P19	4"TRENCH DRAIN	6	6	0.0	0.0	0.0	0.0	Π
1	P20	LAUNDRY SINK	2	2	2.3	2.3	2.3	3.0	Т
2	P21	MOP SINK	2	4	2.3	2.3	4.5	3.0	Т
1	P22	TRIPLE SINK	3	3	3.0	3.0	3.0	4.0	Т
1	P23	URN TROUGH	1	1	0.0	0.0	0.0	0.0	Т
3	P24	3" FLOOR SINK	0	0	0.0	0.0	0.0	0.0	
16	P25	3" FLR DRAIN	2	32	0.0	0.0	0.0	0.0	Т
2	P26	4" FLR DRAIN	2	4	0.0	0.0	0.0	0.0	T
1	P27	ELECTRIC DRINKING FOUNTAIN	0.5	0.5	0.3	0.2	0.2	0.3	
1	P28	BOTTLE FILLING STATION	0.5	0.5	0.3	0.2	0.2	0.3	
1	P29	COM. CLOTHS WASHER W/ 6"TRENCH DRAIN	6	6	6.0	6.0	6.0	8.0	
1	P30	DRINKING FOUNTAIN	0.5	0.5	0.3	0.2	0.2	0.3	
2	P31	HOSE-BIB	0	0	1.0	0.0	0.0	1.0	
5	P32	WALL HYDRANT	0	0	1.0	0.0	0.0	1.0	
1	P33	POOL SHOWER	2	2	1.0	1.0	1.0	1.4	
4	P34	EYEWASH	0	0	0.0	0.0	0.0	0.0	
1	P35	WATER FILTER	0	0	0.0	0.0	0.0	0.0	L
2	P36	AREA DRAIN STORM DRAIN	0	0	0.0	0.0	0.0	0.0	
1	P37	YARD HYDRANT	0	0	2.0	0.0	0.0	1.0	
1	P38	HAND WASH SINK AT BAR	1	1	1.5	1.5	1.5	2.0	Ι
1	P39	BLENDER STATION	1	1	1.5	1.5	1.5	2.0	
472		TOTALS		917			296.5		

JOB TITLE

GROUP II 46514-1953 574/293-C oup3.com

ARCHITECTURAL
201 S. Nappanee St. Elkhart Indiana 4
architecturalgrou

A NEW 98 ROOM HOTEL PORTAGE, MI

RESIDENCE INN BY MARRIOTT

JOB NO. 24109

DATE 05/29/24



SHEET NO. PLUMBING SCHEDULE & DETAILS

TABLE -	_			TAB	LE - 2	
FIXTURE:	COLD	НОТ	PDI SIZE	PIPE SIZE	FIXTURE UNIT LOAD	MODEL NUMBER
WC - TANK	5		Д	1/2"	1 -11	#100
LAY / SINK	1.5	1.5	B	3/4"	12 - 32	*200
URINAL	5		С	1"	33 - 60	#3 <i>00</i>
SERVICE SINK	2.5	2.5	D	1 1/4"	61 - 113	*4 <i>00</i>
DF / EWC LAY	5		E	1 1/2"	114- 154	* 500
SHOWER / TUB LAV	2	2	F	2"	155 - 330	*600
C. WASHER	2	2				

1. ALL MODEL NUMBERS BASED ON ZURN. WATTS, SIOUX CHIEF OR PRECISION PLUMBING PRODUCTS OR APPROVED EQUALS.

2. SIZE UNITS BY REFERRING TO TABLE - I FOR FIXTURE UNIT LOAD AND TABLE - 2 FOR WATER HAMMER ARRESTER SIZE AND MODEL NUMBER.


3. ARRESTERS SHALL HAVE ASSE #1010 AND ANSI #4112.26.1M CERTIFICATION. INSTALL PER PDI STANDARD PDI-WH-201

ADDITIONAL UNIT LOADS NOT LISTED IN TABLE - 1

SEE PLUMBING CODE FOR

WATER HAMMER ARRESTERS

- COMP. SINK

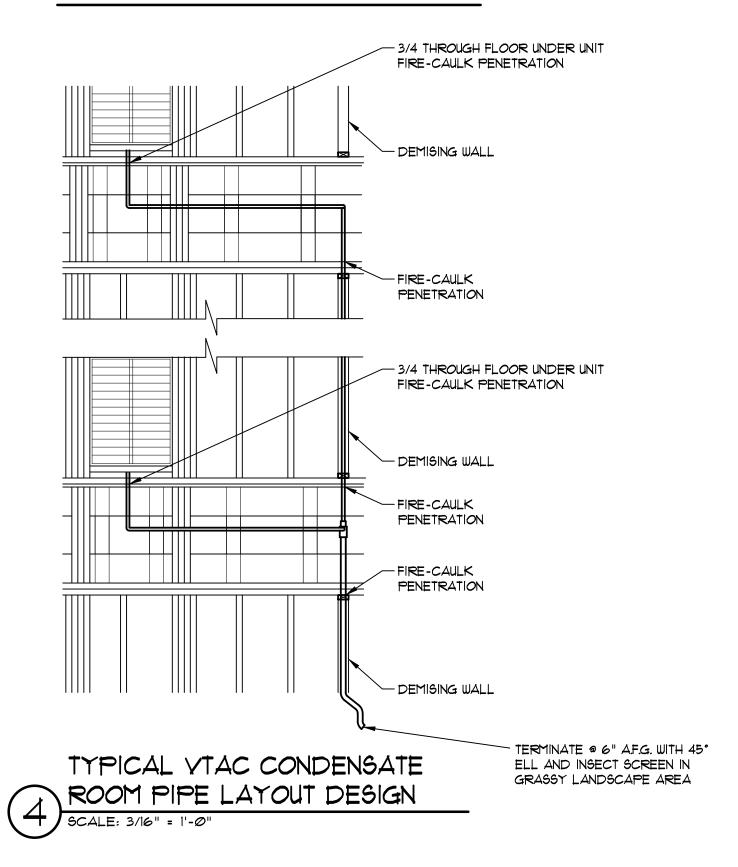

EQUIPMENT SCHEDULE:

FIELD VERIFY WATER PRESSURE AT BEGINNING OF CONSTRUCTION TO CONFIRM REQUIREMENTS REPORTED @ 64 - 10 PSI AND REPORTED @ 19 GRAINS HARDNESS, FIELD VERIFY

WATER HEATER: CYCLONE SEALED COMBUSTION WATER HEATERS 199,000 BTUH. A.O. SMITH BTH-199 W/ MANIFOLD KIT (FURNISH BALL VALVES AS SHOWN ON PLANS). (6 REQUIRED) (1) PMC-10 EXPANSION TANK FOR EACH WATER HEATER (1) VACUUM BREAKER ON INCOMING COLD WATER FOR EACH WATER HEATER

RECIRCULATING PUMP: BELL & GOSSETT MODEL * NBF 22 OR GRUNDFOS MODEL * ALPHA2 25-50N180 OR APPROVED EQUAL.

CIRCUIT SOLVER BALANCING VALVE - MODEL *CS-(SIZE OF PIPE)-(TEMPERATURE OF WATER). EXAMPLE MODEL *C5-1/2-120 TYPICAL ALL OF 3RD FLOOR IS 1/2" PIPE WITH 120° WATER

BACK FLOW PREVENTER: 3" WILKING MDL 375AGT 3" REDUCED PRESGURE ZONE TYPE WITH OG&Y VALVES

I" WILKING MDL #975 INSTALLED AT THE POOL REFILL LINE.

2" WILKINS MDL *975 INSTALLED AT THE YARD IRRIGATION SUPPLY LINE.

THERMOSTATIC MIXING VALVE: ARMSTRONG (THE BRAIN) MODEL (1) DRV40-AD3 WITH THERMOMETER INSTALL PER MANUFACTURERS RECOMMENDATIONS

ZURN/WILKINS MODEL 1070 THERMOSTIC MIXING VALVE SET AT 110° TO BE INSTALLED

ON THE HOT SIDE OF ALL PUBLIC LAYITORIES AND HAND WASHING SINKS

CONTACT (Dennis Whitelaw) 800-807-9827 OR towle-whitney.com

200 GPM @ 33 PSI BOOST 88 PSI SET POINT

26 GALLON NON-ASME TANK

TOWLE WHITNEY TW2018U-180G-40

CULLIGAN MATRIX SYSTEM CSM 210-2NC TRIPLEX PROGRESSIVE DESIGN

(I BRINE TANK REQUIRED) (3 SOFTENER TANKS REQUIRED)


BALANCING VALVE:

<u>SUMP PUMP</u>

BOOSTER PUMPS

WATER SOFTNER

(2 REQUIRED FOR ELEVATOR) ZOELLER SUMP PUMP MODEL *N6161 115V 62 GPM @ 30 FT RISE (I REQUIRED FOR POOL) ZOELLER SUMP PUMP AQUA-MATE N72 1157 38 GPM, WITH 18" SUMP PIT

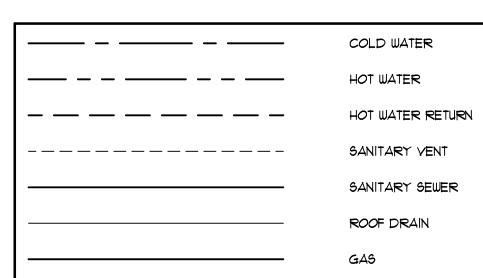



GENERAL PLUMBING NOTES:

- ALL GUEST ROOMS SHALL BE CONTROLLED BY INDIVIDUAL HOT AND COLD SHUT OFF VALVES IN THE CORRIDOR
- 1A. ALL PLUMBING PENETRATIONS SHALL BE SEALED OFF @ EACH FLOOR AS PER THE FIRE CAULKING SPECIFICATIONS.
- IB. ALL PLUMBING SUPPLIES LOCATED WITHIN A GUEST ROOM TO HAVE A 1/4 TURN STOP UNDER THE FIXTURE. TUB AND/OR SHOWERS TO HAVE A INTEGRAL STOP.
- PLUMBING SHALL SUSTAIN 100 PSI TEST IN WATER LINES FOR 24 HRS. (TYP.)
- WATER PIPING MAINS ARE LOCATED IN FIRST FLOOR CEILING SPACE, INSULATE ALL WATER PIPING IN CEILING SPACE.
- 4. ALL DRAINAGE PIPING IN PARTY WALLS SHALL BE INSULATED.

EXPOSED PLASTIC PIPE IN GUESTROOMS, MUST BE CHROME

- INSTALL BALL VALVES AT EACH TAKEOFF ON HOT/COLD WATER IN CEILING OF CORRIDOR TO ISOLATE EACH BRANCH AND WHERE SHOWN ON DWGS.
- COORDINATE LOCATION OF ALL WATER LINES ABOVE CORRIDOR FINISHED CEILING WITH RESPECTIVE TRADES. (TYPICAL)
- ALL WASTE PIPING BELOW SLAB SHALL BE SCH 40 PVC A MINIMUM OF 2". NO
- INSTALL A FULL SIZE ACCESSABLE CLEAN-OUT AT THE BASE OF EVERY STACK, NOT TO BE VISIBLE FROM THE CORRIDOR...
- 9. ALL WORK TO CONFORM TO STATE AND LOCAL PLUMBING AND BACKFLOW PREVENTION CODES AND THE SPECIFICATIONS OF THE LOCAL WATER UTILITY.
- 10. ALL WATER LINES 3" AND LARGER MUST BE DISINFECTED, SAMPLES FROM THREE CONSECUTIVE DAYS MUST BE TAKEN TO AN APPROVED TESTING LAB, AND THE LAB ANALYSES REPORTS MUST BE SUBMITTED TO THE WATER ENGINEERING DEPARTMENT SHOWING THAT THE SAMPLES HAVE PASSED THE TESTS FOR THREE CONSECUTIVE DAYS.
- VACUUM BREAKERS MUST BE INSTALLED ON ALL HOSE BIBS, MOP/SERVICE SINKS, WALL/YARD HYDRANTS.
- PER STATE CODE, BACKFLOW DEVICES ARE TO BE TESTED UPON INSTALLATION AND THEN PERIODICALLY THEREAFTER. SUBMIT COPIES OF TESTS TO THE WATER ENGINEERING DEPARTMENT.
- PLUMBING CONTRACTOR SHALL ROUTE NEW CITY WATER SUPPLY LINE UP THROUGH SLAB INTO MECHANICAL ROOM. INSTALL SLEEVE TO PROTECT CITY WATER LINE FROM CONCRETE. FURNISH AND INSTALL FULL SIZE BUTTERFLY SHUT-OFF VALVE AT CITY WATER ENTRANCE TO MECHANICAL ROOM.
- 14. IN CONCEALED LOCATIONS WHERE PIPING, OTHER THAN CAST-IRON OR GALVANIZED STEEL, IS INSTALLED THROUGH HOLES OR NOTCHES IN STUDS, JOISTS, RAFTERS OR SIMILAR MEMBERS LESS THAN I 1/2" INCHES FROM THE NEAREST EDGE OF THE MEMBER, THE PIPE SHALL BE PROTECTED BY SHIELD PLATES. PROTECTIVE SHIELD PLATES SHALL BE A MINIMUM OF 1/16" INCH THICK STEEL, SHALL COVER THE AREA OF THE PIPE WHERE THE MEMBER IS NOTCHED OR BORED, AND SHALL EXTEND A MINIMUM OF 2 INCHES ABOVE AND BELOW THE PIPE.
- 15. A FRAMING MEMBER SHALL NOT BE CUT, NOTCHED OR BORED IN EXCESS OF LIMITATIONS SPECIFIED IN THE BUILDING CODE.
- 16. FIXTURES WITH CONCEALED SLIP-JOINT CONNECTIONS SHALL BE PROVIDED WITH AN ACCESS PANEL OR UTILITY SPACE AT LEAST 12 INCHES IN ITS SMALLEST DIMENSION OR OTHER APPROVED ARRANGEMENT SO AS TO PROVIDE ACCESS TO THE SLIP CONNECTIONS FOR INSPECTION AND REPAIR. WHERE SUCH ACCESS CANNOT BE PROVIDED, ACCESS DOORS SHALL NOT BE REQUIRED PROVIDED THAT ALL JOINTS ARE SOLDERED, SOLVENT CEMENTED OR SCREWED SO AS TO FORM A SOLID CONNECTION.
- 17. ALL WATER PIPING LESS THAN 1 1/2" SHALL BE INSULATED WITH 1/2" THK. FOAM PIPE INSULATION ALL WATER PIPING GREATER THAN 1 1/2" SHALL BE INSULATED WITH 1" THK, FOAM PIPE INSULATION
- 18. WATER PIPING FOR THE SWIMMING POOL IS NOT SHOWN WITHIN THIS SET OF DRAWINGS, CONSULT WITH POOL MANUFACTURER FOR ALL WATER PIPING REQUIREMENTS. (TYPICAL)
- 19. ALL WATER PIPING ABOVE GRADE SHALL BE FLOWGUARD GOLD CPVC TRUNK LINES AND PEX LINES FROM A MANIFOLD IN THE CORRIDOR TO EA FIXTURE. ALL WATER PIPING BELOW GRADE SHALL BE TYPE 'K' COPPER.
- 20. ALL BRANCH WATER LINES TO PLUMBING FIXTURES SHALL BE MIN 1/2", NO MORE THAN ONE FIXTURE ON 1/2" LINE, (TYPICAL UNLESS OTHERWISE NOTED)
- 21. ALL VALVES SHALL BE FULL PORT BALL VALVES. (TYPICAL)
- 22. INSTALL TEMPERING VALVE IN STRICT ACCORDANCE WITH MANUFACTURE'S WRITTEN INSTALLATION INSTRUCTIONS, MAXIMUM 120° WATER TO GUEST ROOMS,
- 23. ALL PIPING LAYOUTS ARE DIAGRAMMATIC PURPOSES ONLY. (TYP.) ACTUAL PIPING TO BE COORDINATED WITH OTHER TRADES & FRAMING MEMBERS.
- 24. INSTALL CIRCUIT SOLVER BALANCING YALVES ON ALL HOT WATER CIRCULATING
- BRANCH LINES. 25. FURNISH AND INSTALL 1/2" COLD WATER PIPING WITH BALL VALVES TO ALL ICE MACHINES.
- 26. 11/4" TAKE OFFS WITH FULL PORT BALL VALVES TO ALL PLUMBING GROUPS WITH 11/4" RISERS UP TO THE MID LEVEL FLOORS, I" RISER UP TO THE TOP FLOOR, I" RUNS INTO EACH ROOM. 1/2" RETURN ON HOT SIDE FROM THE TOP FLOOR WITH A BALANCING
- VALVE ABOVE CEILING 27. ALL WATER CLOSETS TO HAVE 3" DRAIN PIPE
- 28. FURNISH AND INSTALL TRAP PRIMER ON ALL FLOOR DRAINS
- 29. HORIZONTAL BRANCHES SHALL CONNECT TO THE BASES OF STACKS AT A POINT LOCATED NOT LESS THAN 10 TIMES THE DIAMETER OF THE DRAINAGE STACK DOWNSTREAM FROM THE STACK. 40 INCHES FOR A 4" STACK
- HORIZONTAL ROOF DRAIN PIPING MUST BE INSULATED WITH 3/4" THICK FOAM INSULATION
- 32. WATER HAMMER ARRESTORS ON HOT AND COLD WATER SUPPLY PIPES IN EACH PLUMBING GROUP ON EACH FLOOR REFER TABLE ON SHEET PO.2.
- 33. ALL PIPING TO BE SUPPORTED ACCORDING TO THE LOCAL PLUMBING CODE OR PER MANUFACTURE'S INSTRUCTIONS WHICHEVER IS MOST STRINGENT. PIPE SUPPORTS ARE TO BE DESIGNED FOR THE PIPE BEING SUPPORTED.
- 34. ALL METAL PIPING TO BE INSULATED WITH CLOSED-CELL ELASTOMERIC INSULATION.

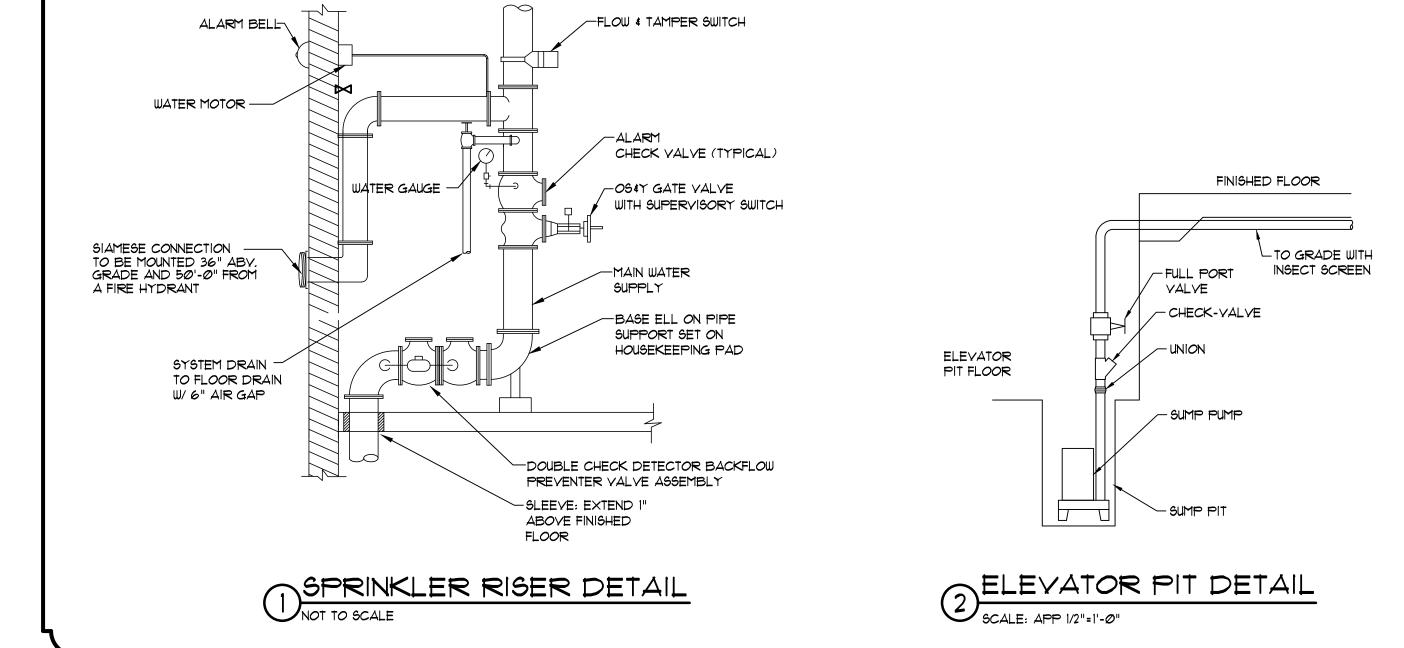

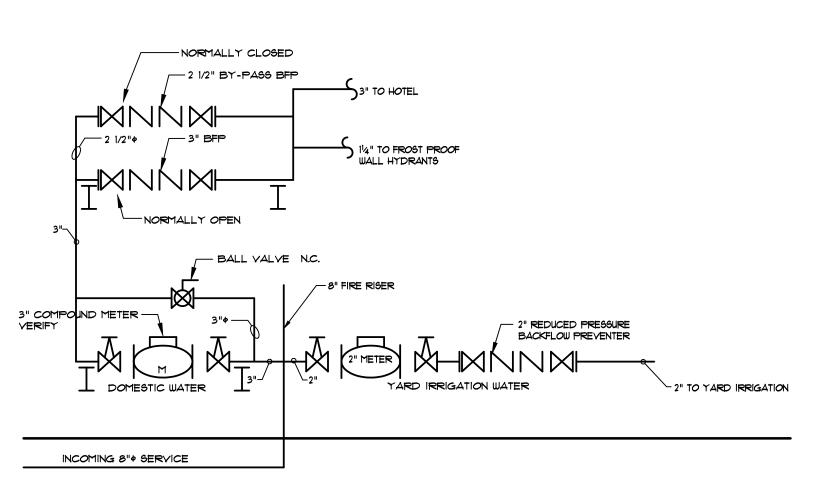

3 ELEVATION DETAIL IN METER ROOM SCALE: N.T.S.

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JOB NO.

DATE

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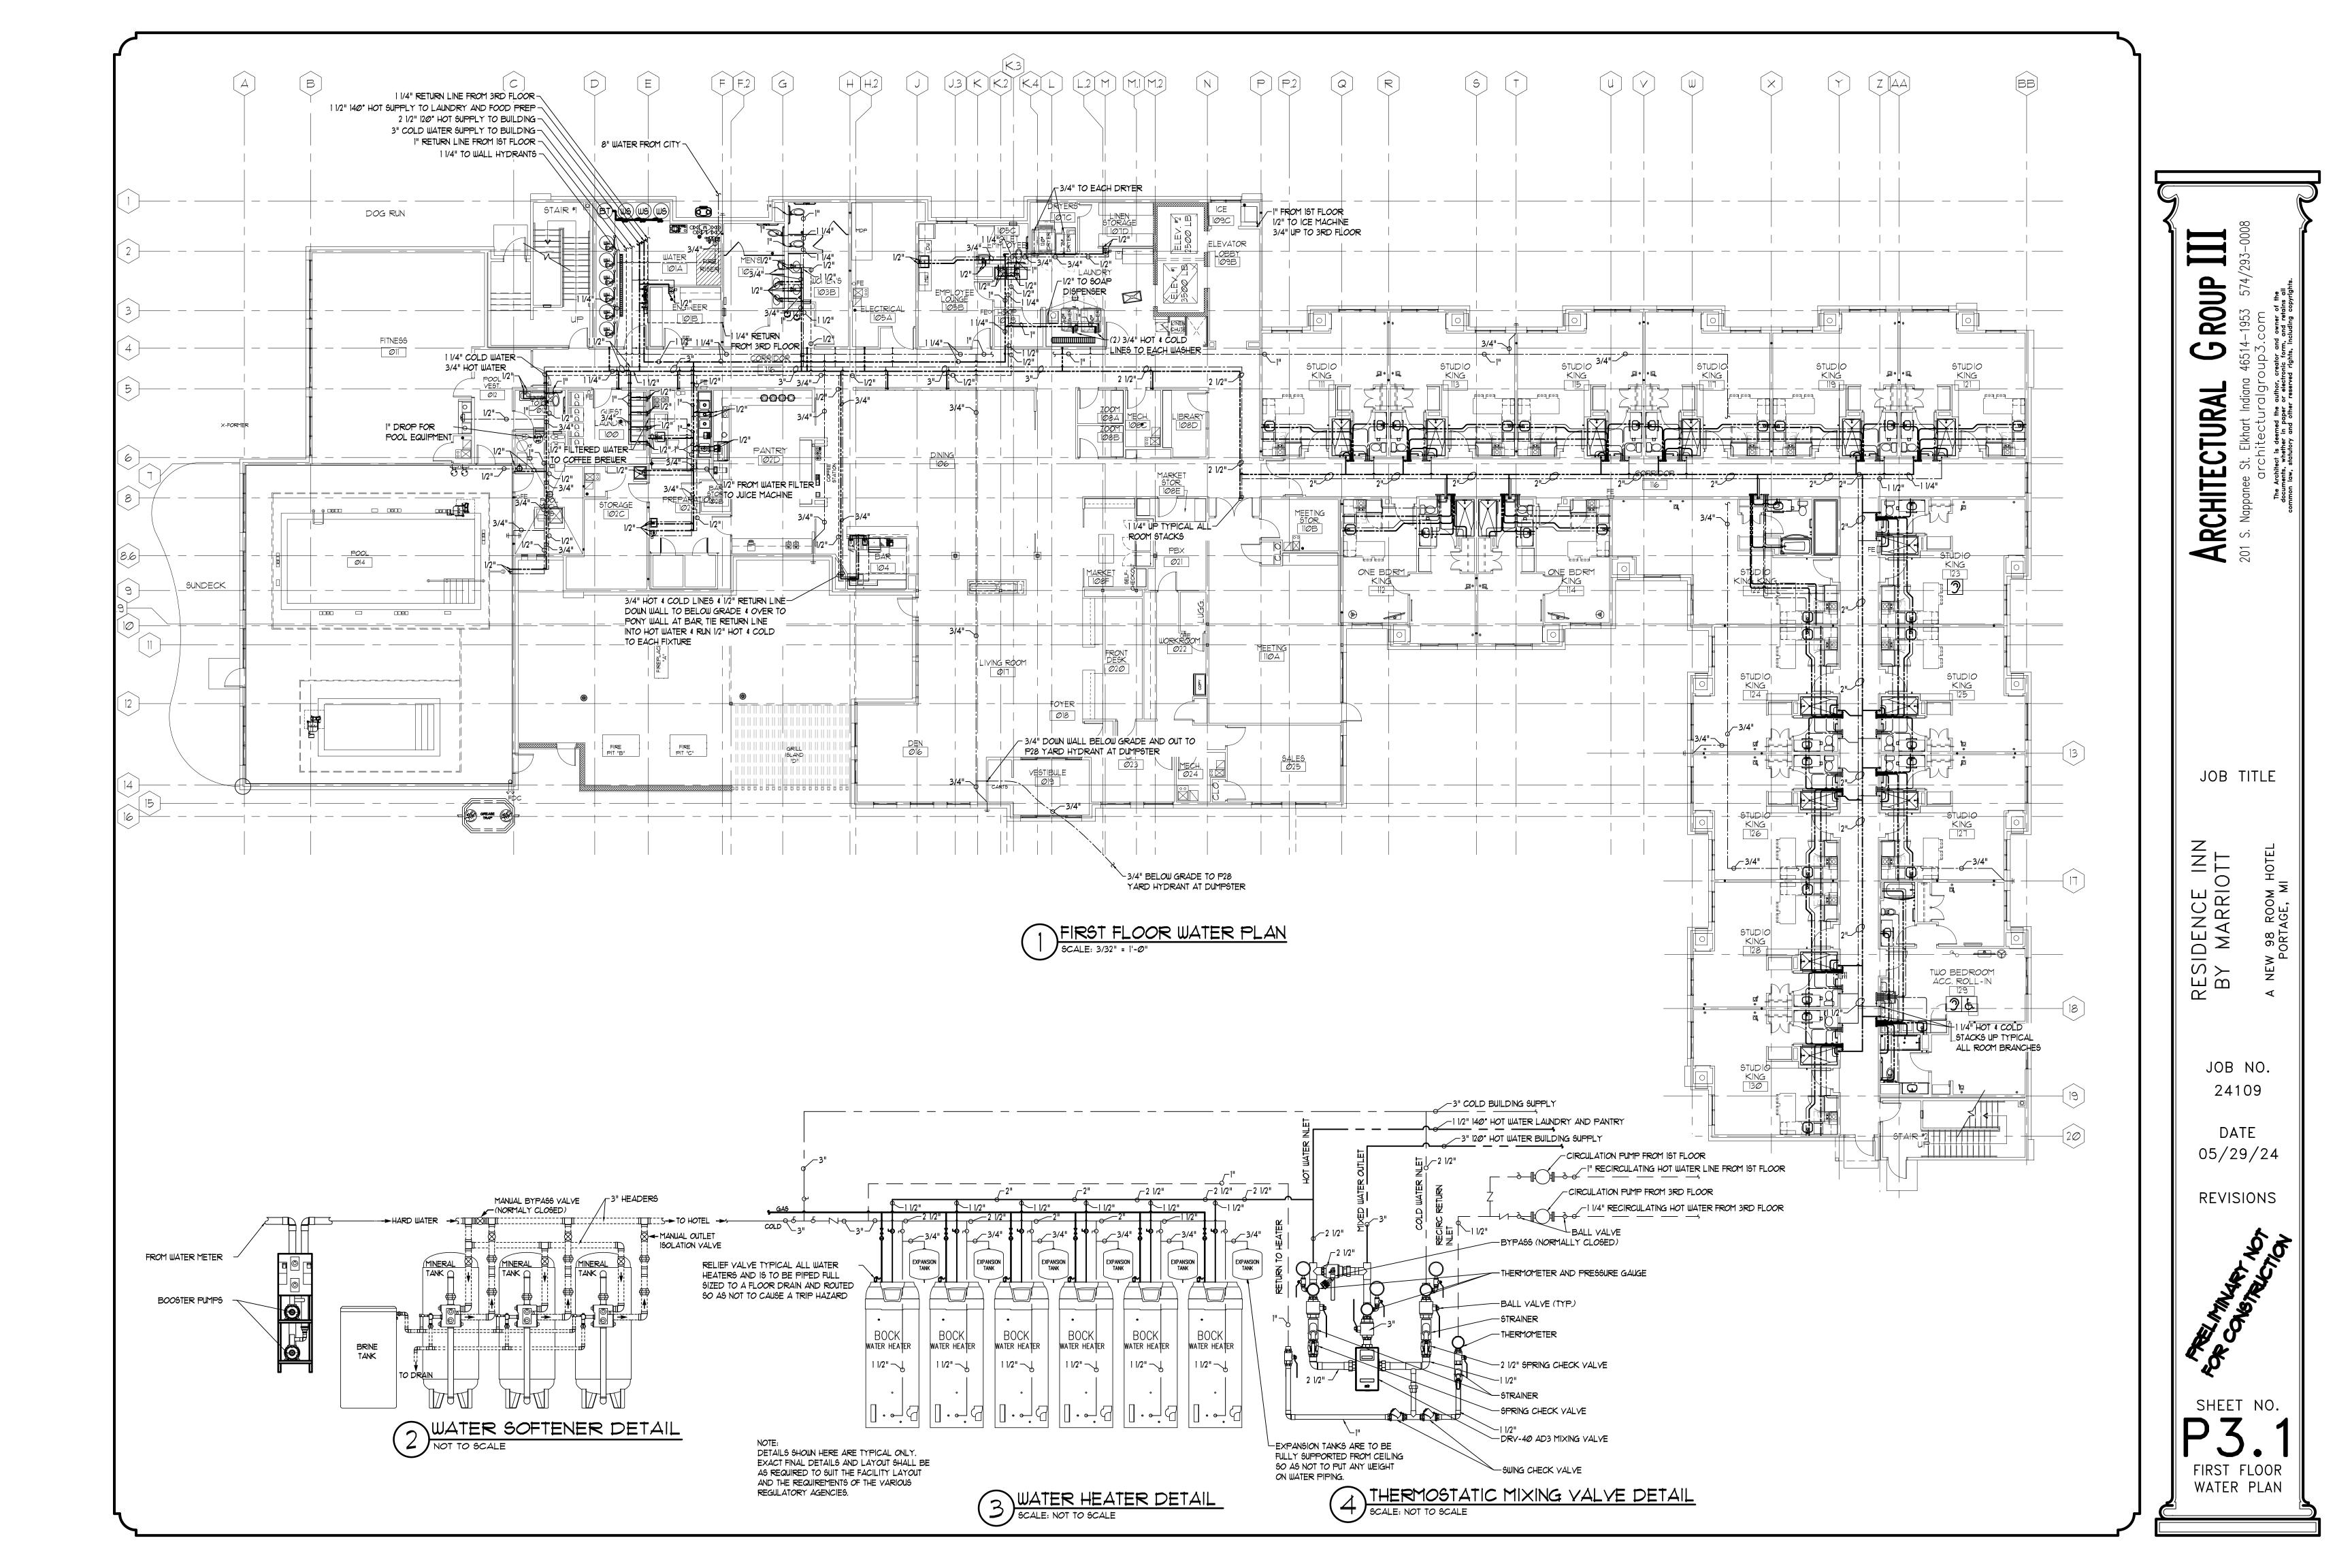
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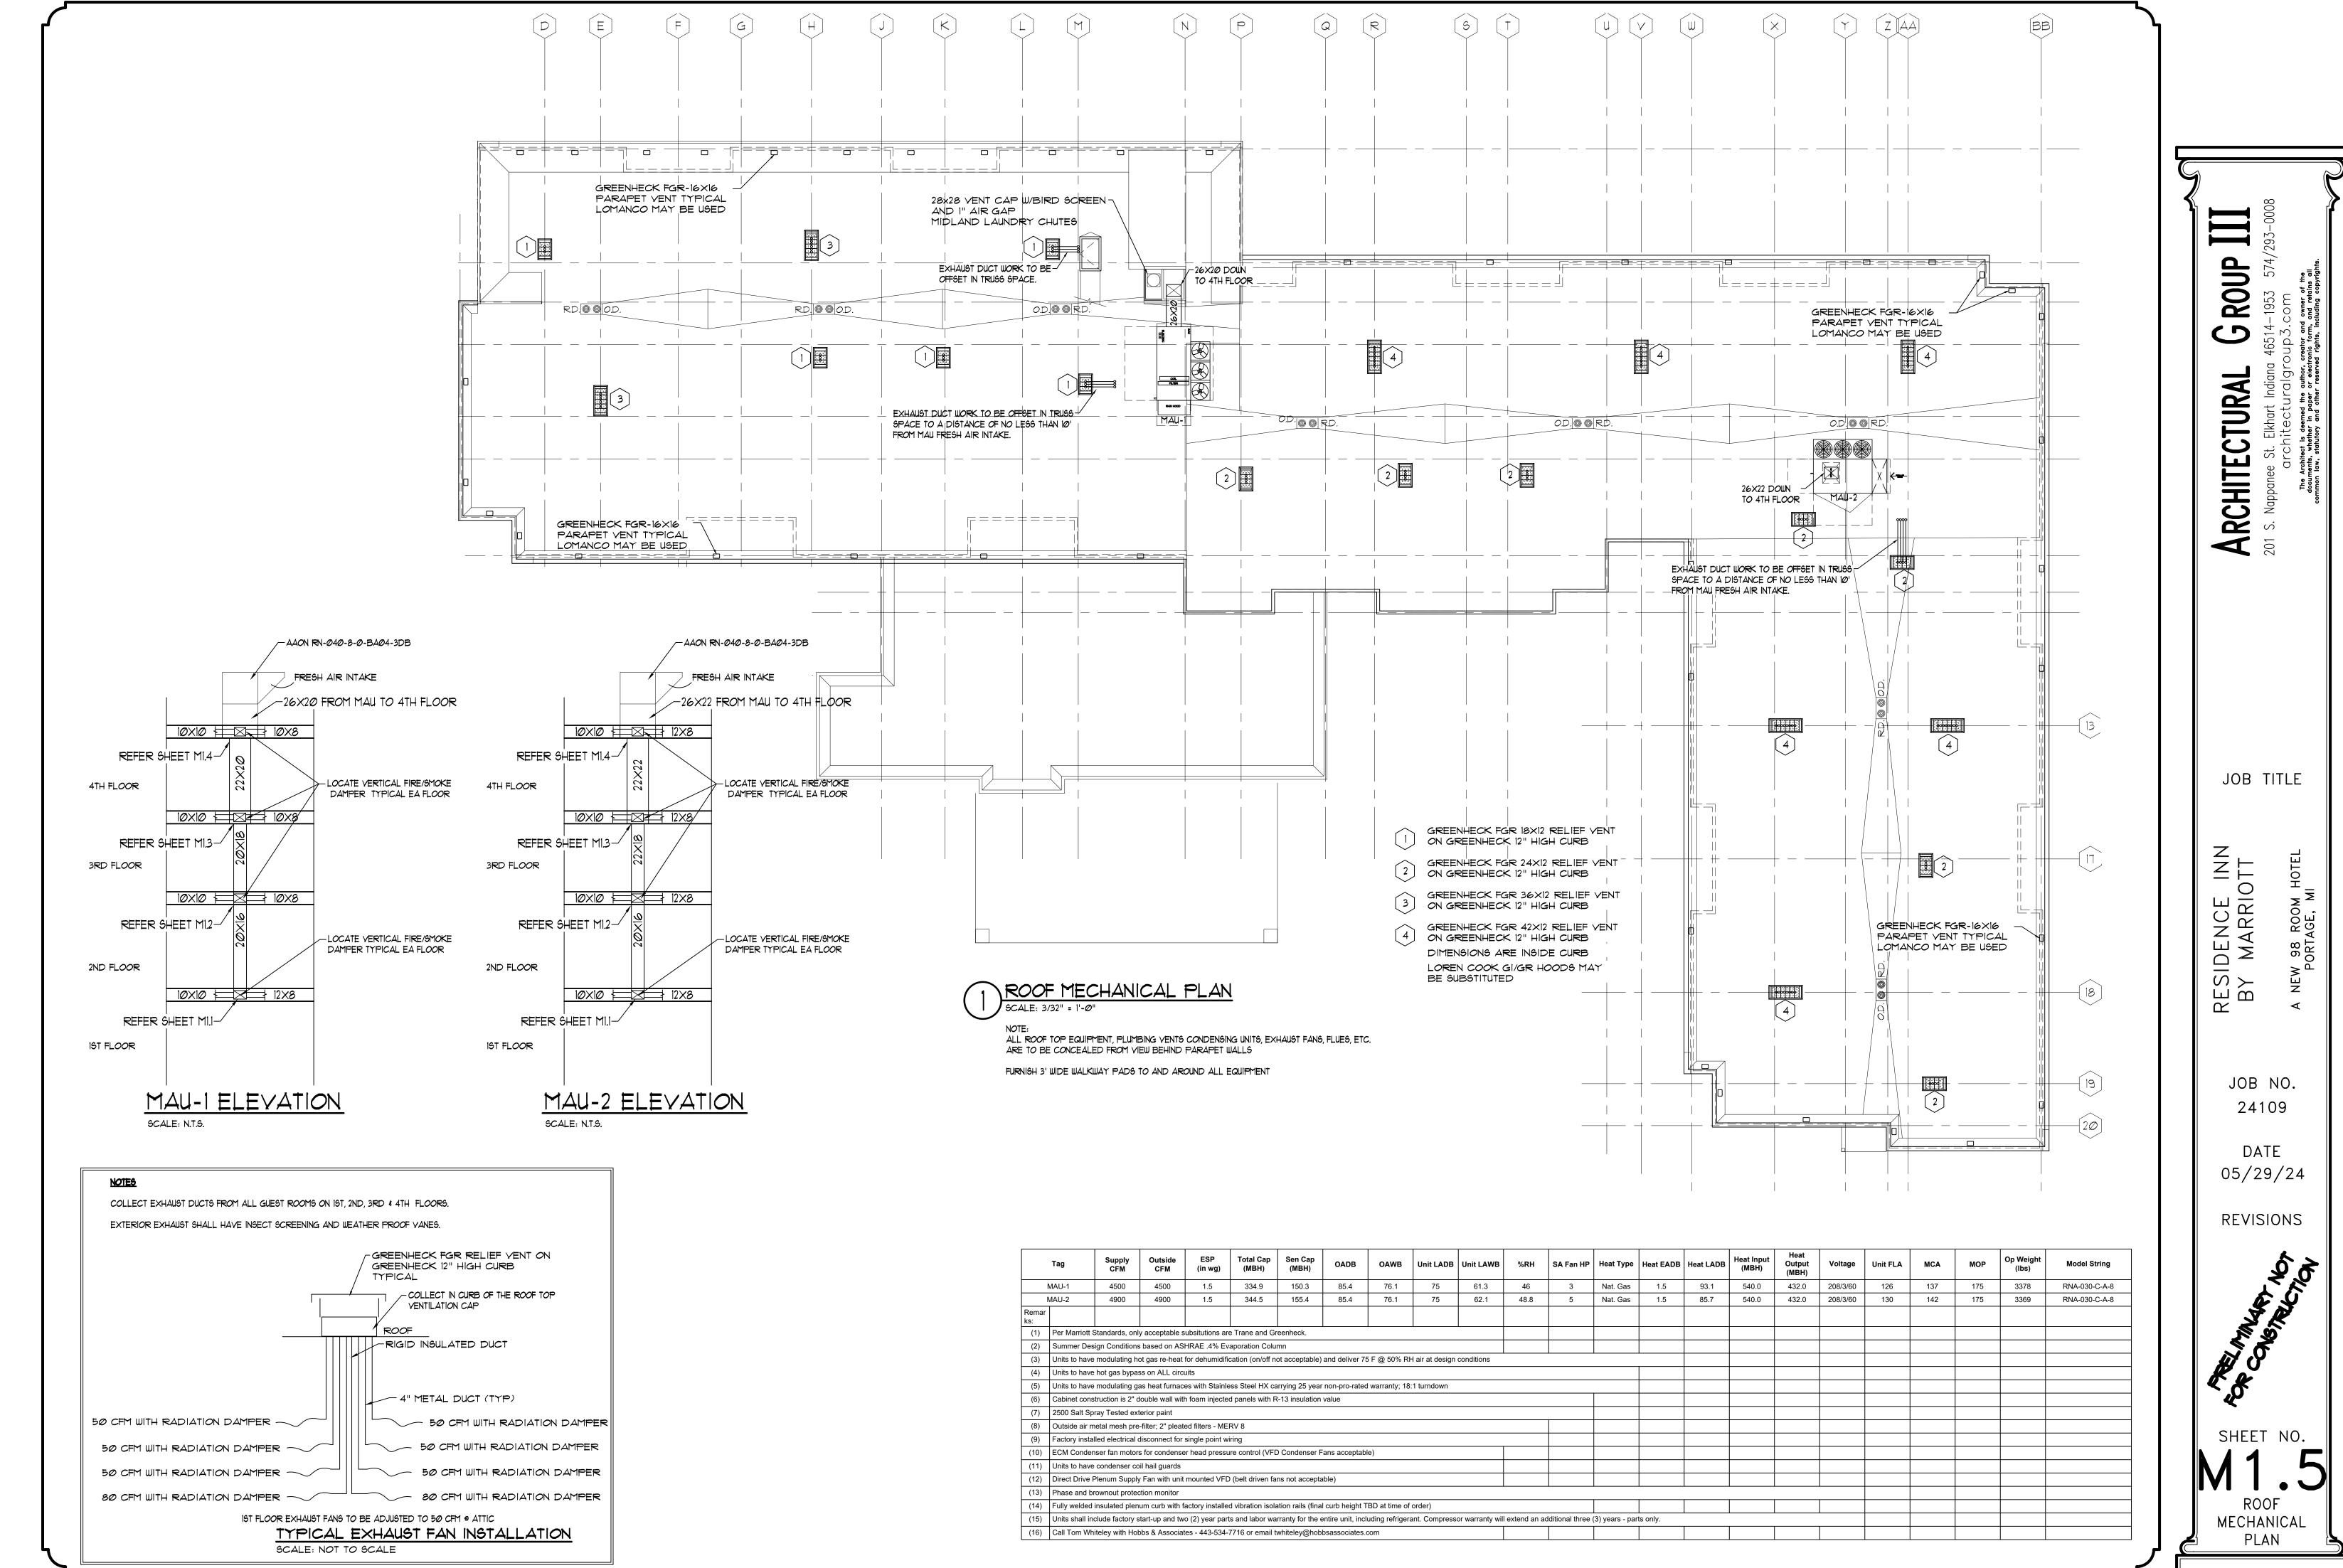
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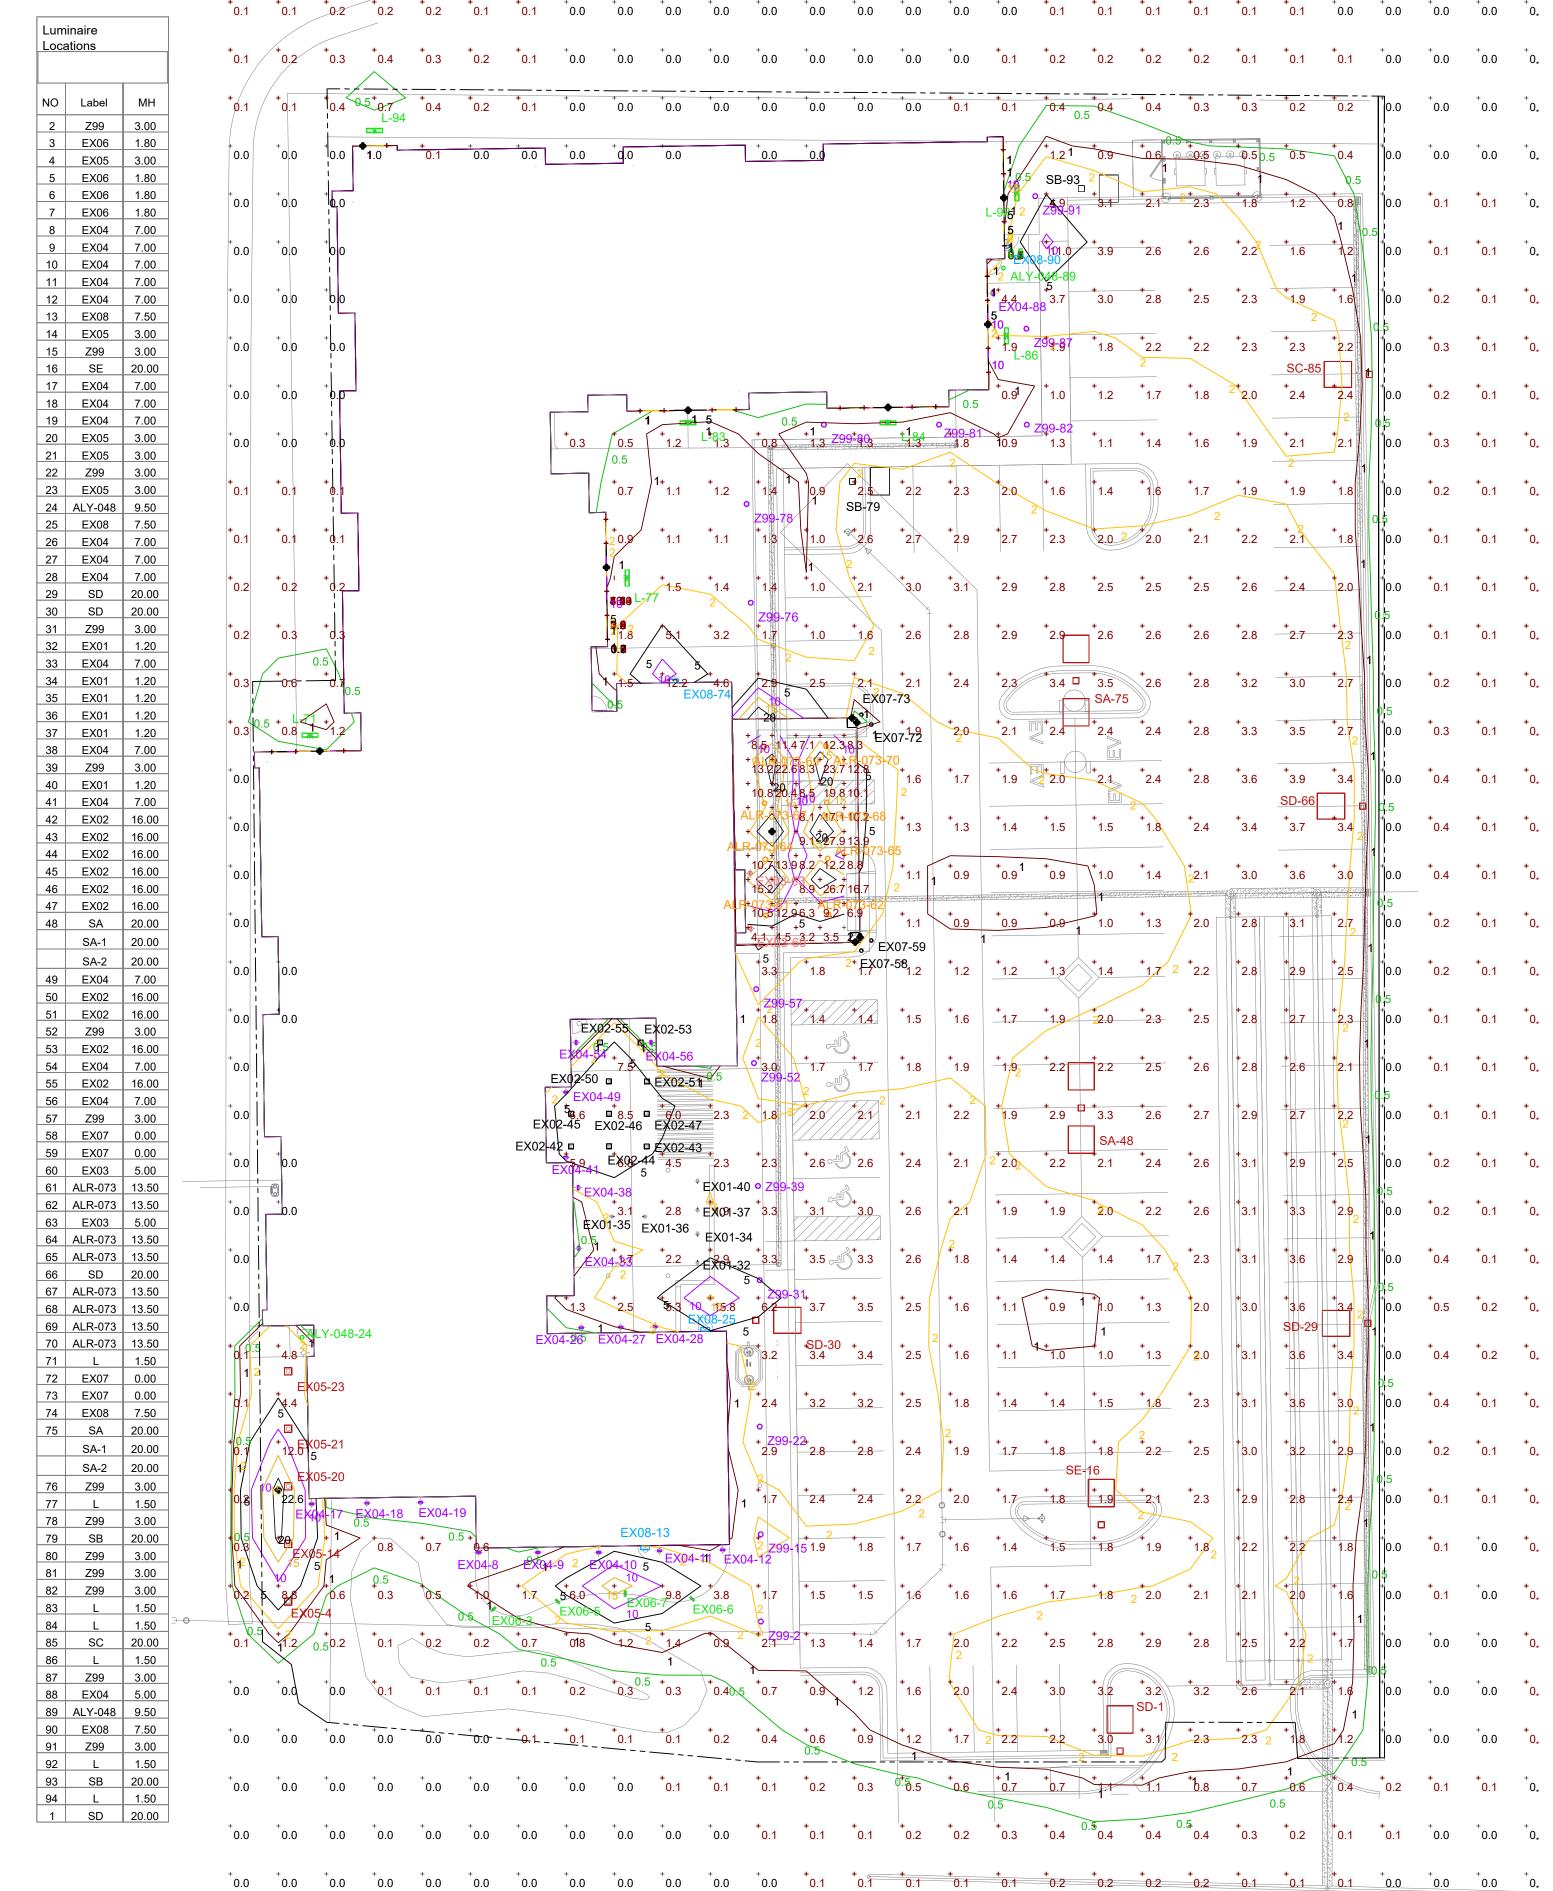
SHEET NO. PLUMBING SCHEDULE &

DETAILS





Symbol	Label	QTY	Manufacturer	Catalog	Description	Number Lamps	Lamp Output	LLF	Input Power
	ALR- 073	8	COOPER LIGHTING SOLUTIONS - HALO (FORMERLY EATON)	HL618TAT - HLM6930 - HL6NFL - 455H	HALO ALLSLOPE 6" 30W, Semi-Specular Haze Reflector, White Metal Trim Ring using 25 Degree Optic at a 6-12 Pitch	1	2105	1	27.6
	ALY- 048 COOPER LIGHTING SOLUTIONS - BRAND (FORMERLY EATON) LD6B10D010 EU6B10208040 6LBMB1 PORTFOLIO 6 INCH 50 DEGREE RECESSED DOWNLIGHT MEDIL DISTRIBUTION WITH SPECULAR TRIM WATTAGE D010TR-10.05 W 10.58 W D5LT-10.2 W DMX-10.6 W		PORTFOLIO 6 INCH 50 DEGREE CUTOFF RECESSED DOWNLIGHT MEDIUM DISTRIBUTION WITH SPECULAR BLACK TRIM WATTAGE D010TR-10.05 W DE010- 10.58 W D5LT-10.2 W DMX-10.6 W DL2- 11.8 W DL3-11.1 W DLE-11.39 W	1	479	1	9.9		
	EX01	6	Visual Comfort & Co.	700OSIKN92730x120	Ikon Step	1	204	1	12.3
	EX02	10	DALS LIGHTING	DLS969787	4" SQ DOWNLIGHT WIDESPREAD LIGHT BEAM	1	912	1	11.2259
	EX03	2	GENERATION BRANDS	7000WASP93026DHUNV S	LED WALL SCONCE	1	1034	1	37.8
	EX04	18	GENERATION BRANDS	7000WASPW93015DZUN VS	LED WALL SCONCE	1	629	1	21.9
	EX05	5	KUZCO LIGHTING	EB2936-BK	BOLLARD	1	1376	1	22.5
	EX06	4	Generation Brands	700OBSTR42SC1UNV830 C	LED BOLLARD	1	1254	1	19.4
	EX07	4	Hydrel	IGF6 P2 80CRI 30K MVOLT 30DEG ISS	IGF6 P2 80CRI 3000K 120-277V 30DEG No Tilt Internal Source Shield	1	1393	1	16.67
	EX08	4	Lithonia Lighting	ARC1 LED P3 30K	ARC1 LED WITH P3 - PERFORMANCE PACKAGE, 3000K	1	2858	1	24.5247
	L	7	Lithonia Lighting	DSXF2 LED P3 30K 70CRI NSP BV	DSX Floodlight Luminaire Size 2 P3 Lumen Package 3000K CCT 70CRI Type NSP Distribution with Bottom visor	1	11391	1	99.795
	SA	2	Lithonia Lighting	DSX1 LED P1 30K 70CRI T2M HS	D-Series Size 1 Area Luminaire P1 Performance Package 3000K CCT 70 CRI Type 2 Medium Houseside Shield	1	6250	1	101.803
	SB	2	Lithonia Lighting	DSX0 LED P1 30K 80CRI LCCO	D-Series Size 0 Area Luminaire P1 Performance Package 3000K CCT 80 CRI Left Corner Cutoff Extreme Backlight Control	1	3063	1	33.21
	SC	1	Lithonia Lighting	DSX1 LED P1 30K 70CRI TFTM HS	D-Series Size 1 Area Luminaire P1 Performance Package 3000K CCT 70 CRI Forward Throw Houseside Shield	1	6245	1	50.901
	SD	4	Lithonia Lighting	DSX1 LED P3 30K 70CRI T2M HS	D-Series Size 1 Area Luminaire P3 Performance Package 3000K CCT 70 CRI Type 2 Medium Houseside Shield	1	11327	1	102.172
	SE	1	Lithonia Lighting	DSX1 LED P1 30K 70CRI T2M HS	D-Series Size 1 Area Luminaire P1 Performance Package 3000K CCT 70 CRI Type 2 Medium Houseside Shield	1	6250	1	50.901
	Z99	14	PHILIPS-HADCO LIGHTING	RF6AK512LE	RF6 BOLLARD	1	346	1	12.7



ROUP 9 ARCHITECTURAL 201 S. Nappanee St. Elkhart Indiana JOB TITLE RESIDENCE INN BY MARRIOTT JOB NO. 24109 DATE 05/29/24 REVISIONS

SHEET NO.

SITE PLAN PHOTOMETRICS

