

3 WORKING DAYS BEFORE YOU DIG
CALL MISS-DIG®
1-800-482-7171

ALTERNATE NUMBER (248) MISS-DIG
 COLOR CODES FOR UTILITY LOCATING:



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|--------|---------------------|-------|-------------|
| Yellow | OIL & GAS | Blue | WATER |
| Orange | PHONE & CATV | Green | STORM DRAIN |
| Red | ELECTRIC | Brown | SEWER |
| White | PROPOSED EXCAVATION | Pink | SURVEYING |

IF YOU ARE GOING TO WORK NEAR OVERHEAD WIRES ... CALL MISS DIG


- EXISTING CONDITIONS AND DEMOLITION NOTES:**
- EXISTING TOPOGRAPHY SHOWN REPRESENTS SITE CONDITIONS AS PREPARED BY OTHERS ON OCTOBER 2023. CONTRACTOR SHALL INSPECT SITE PRIOR TO BIDDING WORK TO VERIFY ACTUAL FIELD CONDITIONS AS PORTIONS OF THE DEMOLITION WORK MAY HAVE SINCE BEEN COMPLETED. CONTRACTOR SHALL BE RESPONSIBLE TO COMPLETE ALL DEMOLITION WORK AS PER PLANS TO PREPARE THE SITE FOR CONSTRUCTION OF PROPOSED IMPROVEMENTS.
 - THE UNDERGROUND UTILITY INFORMATION AS SHOWN HEREON IS BASED, IN PART, UPON INFORMATION FURNISHED BY UTILITY COMPANIES AND THE LOCAL MUNICIPALITY. WHILE THIS INFORMATION IS BELIEVED TO BE RELIABLE, ITS ACCURACY AND COMPLETENESS CANNOT BE GUARANTEED NOR CERTIFIED TO.
 - THE CONTRACTOR IS RESPONSIBLE FOR DEMOLITION, REMOVAL AND DISPOSAL (IN A LOCATION APPROVED BY ALL JURISDICTIONAL GOVERNING ENTITIES) OF ALL STRUCTURES, PADS, WALLS, FLUMES, FOUNDATIONS, ROAD, PARKING LOTS, DRIVES, DRAINAGE STRUCTURES, UTILITIES, ETC., SUCH THAT THE IMPROVEMENTS SHOWN ON THESE PLANS CAN BE CONSTRUCTED. ALL DEMOLITION WORK SHALL BE IN ACCORDANCE WITH ALL APPLICABLE FEDERAL, STATE AND LOCAL REQUIREMENTS. ALL FACILITIES TO BE REMOVED SHALL BE UNDERCUT TO SUITABLE MATERIAL AND BROUGHT TO GRADE WITH SUITABLE COMPACTED FILL MATERIAL PER THE SPECIFICATIONS.
 - REFER TO SPECIFICATIONS SHEET FOR DEMOLITION NOTES.

DEMOLITION LEGEND

| | |
|-----------|----------------------------------------------------------------------------------|
| [Pattern] | BITUMINOUS PAVEMENT AND BASE TO BE REMOVED |
| [Pattern] | CONCRETE PAVEMENT AND BASE TO BE REMOVED |
| [Pattern] | AGGREGATE TO BE REMOVED |
| --- | SAWCUT LINE |
| X X X | FENCE, RETAINING WALL, RAILROAD TIES, POLES, CURB AND GUTTER, ETC. TO BE REMOVED |
| X X X | UTILITY STRUCTURE TO BE REMOVED |
| /// | UTILITY LINE REMOVAL, FILL OR ABANDONMENT (REFER TO SPECIFICATIONS) |
| (TBR) | TO BE REMOVED |
| (TR) | TO REMAIN |

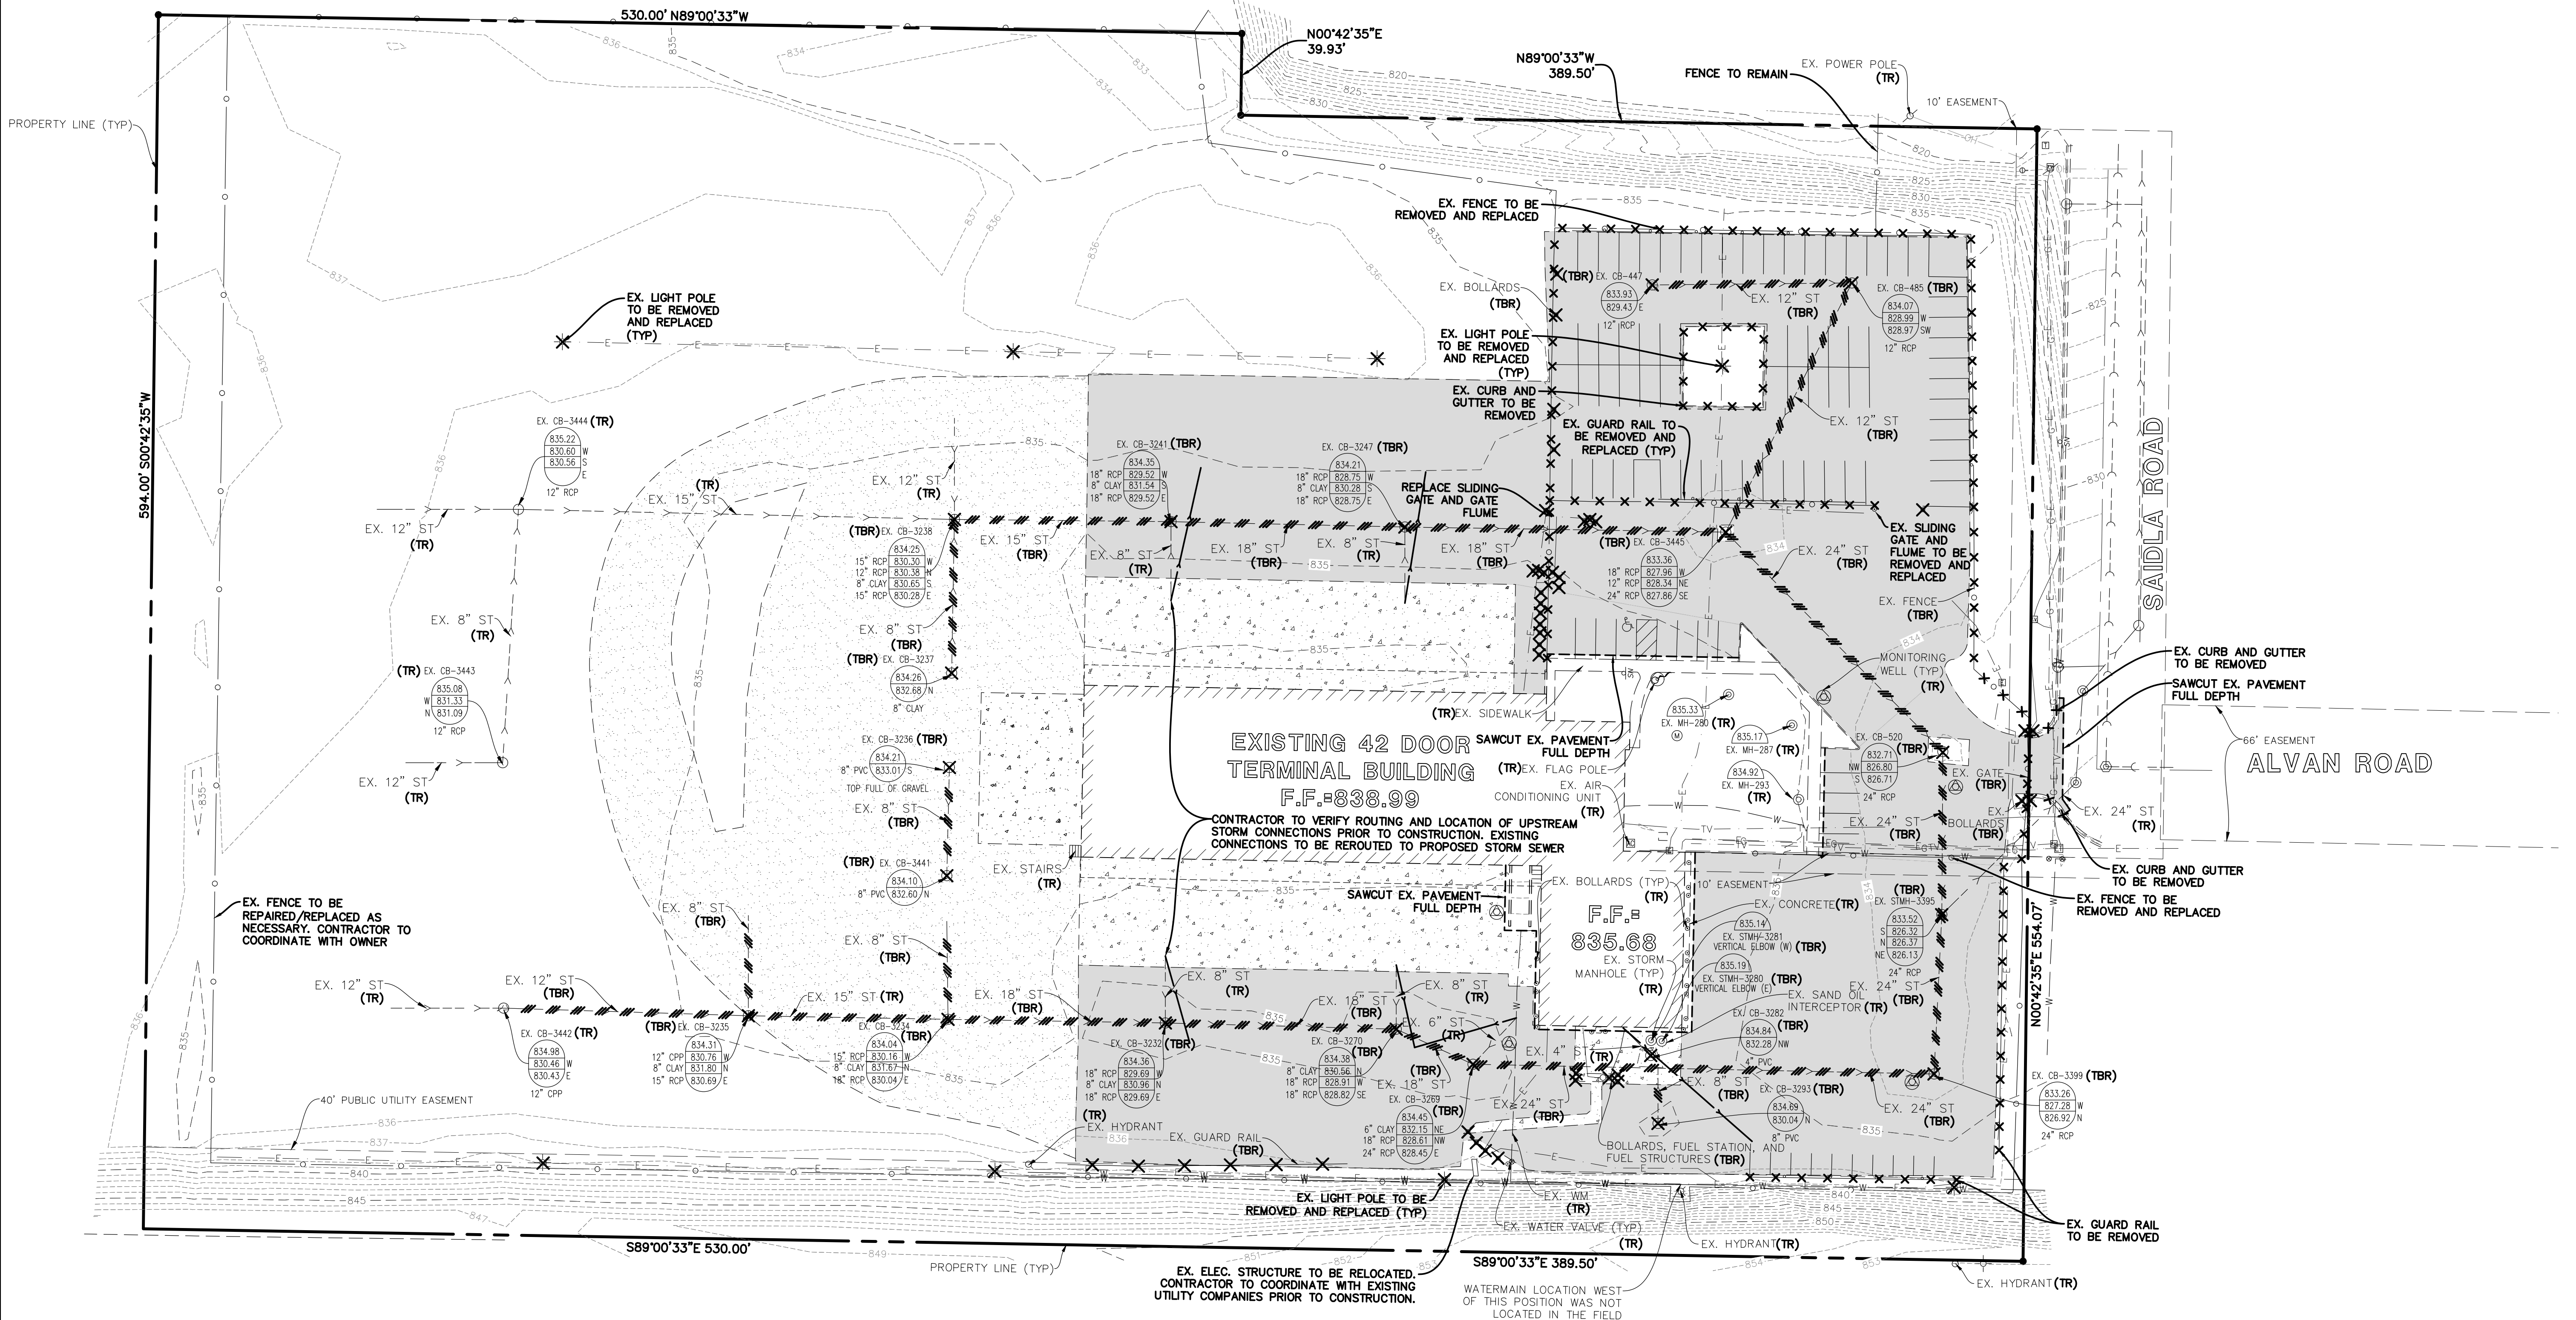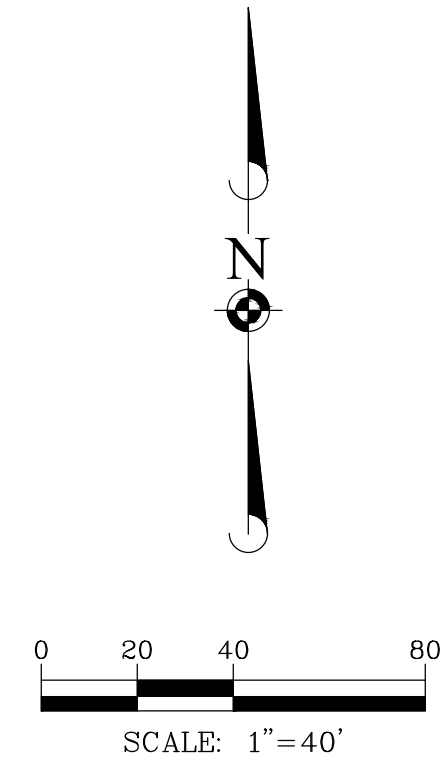

MARCH 15, 2024 - 13:03 Doc Name: P:\04\kamin01\04\15\Task\Drawings\Plan\541\Construction Document\EXISTING CONDITIONS AND DEMO PLAN.dwg, Updated By: Chrimson

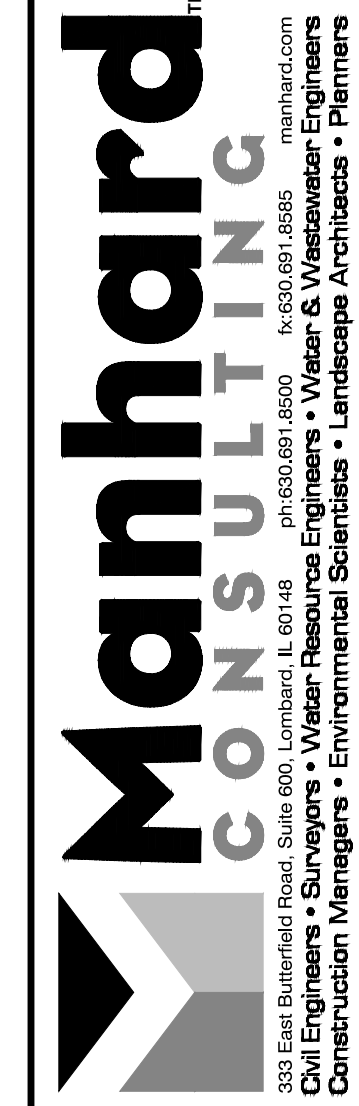

OLD DOMINION FREIGHT LINE - KALAMAZOO
CITY OF KALAMAZOO, MICHIGAN
EXISTING CONDITIONS AND DEMOLITION PLAN


| | |
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| PROJ. MGR: | JAR |
| PROJ. ASSOC.: | AJH |
| DRAWN BY: | JDP |
| DATE: | 03/21/2024 |
| SCALE: | 1"=40' |
| SHEET | |
| 2 OF 10 | |
| ODF.KAMI.01 | |

PENDING APPROVAL - NOT FOR CONSTRUCTION

CONSTRUCTION SEQUENCE:

- INSTALL SILT FENCE AT LOCATIONS AS INDICATED ON THE PLANS.
- PROVIDE STABILIZED CONSTRUCTION ENTRANCE.
- CONSTRUCT TEMPORARY DITCHES, SWALES, SEDIMENT TRAPS AND/OR BASINS.
- STRIP EXISTING TOPSOIL FROM PROPOSED LIMITS OF DISTURBANCE AND STOCKPILE WHERE SHOWN ON PLANS.
- PROVIDE SILT FENCE AROUND THE BASE OF THE STOCKPILES.
- CONSTRUCT STORMWATER MANAGEMENT (DETENTION) FACILITIES TO SUB-GRADE AND INSTALL OUTLET PIPES.
- COMPLETE TOPSOIL PLACEMENT AND PERMANENT SEEDING AND SODDING OF STORMWATER MANAGEMENT FACILITIES.
- CUT AND FILL SITE TO PLAN SUB-GRADE.
- CONSTRUCT UNDERGROUND IMPROVEMENTS, I.E. SANITARY SEWER WATERMAIN AND STORM SEWER**, ETC.
- CONSTRUCT PAVEMENT IMPROVEMENTS PER PLAN.
- COMPLETE CONSTRUCTION OF SITE WITH PERMANENT STABILIZATION.
- REMOVE TEMPORARY EROSION AND SEDIMENT CONTROL MEASURES.
- ** INSTALL INLET PROTECTION AROUND DRAINAGE STRUCTURES AS CONSTRUCTED.

LEGEND

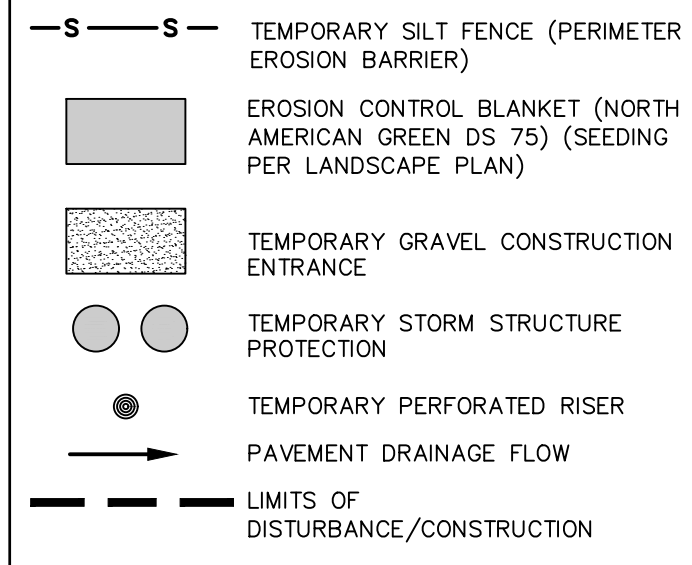

SOIL EROSION AND SEDIMENTATION CONTROL GENERAL NOTES:

- ALL VEGETATIVE AND STRUCTURAL EROSION CONTROL PRACTICES SHALL BE CONSTRUCTED AND MAINTAINED IN ACCORDANCE WITH THE MINIMUM STANDARDS AND SPECIFICATIONS OF THE "ILLINOIS URBAN MANUAL".
- MAINTENANCE AND REPLACEMENT OF EROSION CONTROL ITEMS, WHEN DIRECTED BY THE OWNER, SHALL BE CONSIDERED AS INCIDENTAL TO THE CONTRACT.
- THE CONTRACTOR SHALL INSPECT ALL EROSION CONTROL MEASURES AT LEAST ONCE EVERY SEVEN (7) CALENDAR DAYS AND WITHIN 24 HOURS OF THE END OF A STORM THAT IS 0.5 INCHES OR GREATER, OR EQUIVALENT SNOWFALL, WHEN THE SNOW MELTS AND THERE IS POTENTIAL FOR EROSION. ANY NECESSARY REPAIRS OR CLEANUP TO MAINTAIN THE EFFECTIVENESS OF SAID MEASURES SHALL BE MADE IMMEDIATELY.
- INSTALL ALL PERIMETER SILT FENCING PRIOR TO ANY CLEARING OR GRADING. ONSITE SEDIMENT CONTROL MEASURES AS SHOWN AND SPECIFIED BY THIS EROSION AND SEDIMENTATION CONTROL PLAN SHALL BE CONSTRUCTED AND FUNCTIONAL PRIOR TO INITIATING CLEARING, GRADING, STRIPPING, EXCAVATION OR FILLING ACTIVITIES ON THE SITE.
- STORM WATERS FALLING ON THE ENTIRE SITE SHALL BE DIVERTED INTO THE DETENTION BASIN, PRIOR TO BEGINNING MASS EXCAVATION. THE CONTRACTOR SHALL CONSTRUCT DITCHES, SWALES, SEDIMENTATION TRAPS AND SILTATION CONTROL MEASURES AS REQUIRED TO INTERCEPT SURFACE WATERS BEFORE THEY FLOW ONTO ADJACENT PROPERTY AND CONVEY THEM TO THE DETENTION BASIN.
- IF STORMWATER DETENTION IS NOT REQUIRED THE CONTRACTOR SHALL CONSTRUCT DITCHES, SWALES, SEDIMENT TRAPS AND SILTATION CONTROL MEASURES AS REQUIRED TO INTERCEPT SURFACE WATERS BEFORE THEY FLOW ONTO ADJACENT PROPERTY.
- STABILIZATION OF DISTURBED AREAS MUST BE INITIATED IMMEDIATELY WHENEVER ANY CLEARING, GRADING, EXCAVATING OR OTHER EARTH DISTURBING ACTIVITIES HAVE PERMANENTLY CEASED ON ANY PORTION OF THE SITE, OR TEMPORARILY CEASED ON ANY PORTION OF THE SITE AND WILL NOT RESUME FOR A PERIOD EXCEEDING 14 CALENDAR DAYS. STABILIZATION OF DISTURBED AREAS MUST BE INITIATED WITHIN 1 WORKING DAY OF PERMANENT OR TEMPORARY CESSATION OF EARTH DISTURBING ACTIVITIES AND SHALL BE COMPLETED AS SOON AS POSSIBLE BUT NOT LATER THAN 14 DAYS FROM THE INITIATION OF STABILIZATION WORK IN AN AREA.
- TEMPORARY SEED MIXTURE SHALL BE APPLIED AT 64 LBS/ACRE.
- INLET PROTECTION SHALL BE INSTALLED UNDER THE GRATING OF EACH DRAINAGE STRUCTURE.
- STABILIZATION OF TOPSOIL STOCKPILES SHALL BE INITIATED IMMEDIATELY UPON COMPLETION UNLESS THEY WILL BE DISTURBED WITHIN FOURTEEN (14) CALENDAR DAYS. STABILIZATION OF STOCKPILES MUST BE INITIATED WITHIN 1 WORKING DAY OF PERMANENT OR TEMPORARY CESSATION OF EARTH DISTURBING ACTIVITIES AND SHALL BE COMPLETED AS SOON AS POSSIBLE BUT NOT LATER THAN 14 DAYS FROM THE INITIATION OF STABILIZATION WORK IN AN AREA. ALL SOIL STORAGE PILES SHALL BE PROTECTED FROM EROSION WITH SILT FENCE ON THE DOWN SLOPE SIDE OF THE PILES.
- DURING DEWATERING OPERATIONS, WATER WILL BE PUMPED INTO SEDIMENT BASINS OR SILT TRAPS. DEWATERING DIRECTLY INTO FIELD TILES OR STORMWATER STRUCTURES IS PROHIBITED.
- WATER PUMPED DURING CONSTRUCTION OPERATION SHALL BE FILTERED.
- DUST CONTROL SHALL BE PERFORMED ON A DAILY BASIS USING WATER DISPERSED FROM A TRUCK MOUNTED TANK WITH STANDARD DISCHARGE HEADER TO PROVIDE A UNIFORM RATE OF APPLICATION.
- TEMPORARY GRAVEL CONSTRUCTION ENTRANCES SHALL BE MAINTAINED, ADJUSTED OR RELOCATED AS NECESSARY TO PREVENT SEDIMENT FROM BEING TRACKED ONTO PUBLIC ROADWAYS. ANY SEDIMENT REACHING A PUBLIC ROAD SHALL BE REMOVED BY SHOVELING OR STREET CLEANING BEFORE THE END OF EACH WORKING DAY.
- ANY LOOSE MATERIAL THAT IS DEPOSITED IN THE FLOW LINE OF ANY GUTTER OR DRAINAGE STRUCTURE DURING CONSTRUCTION OPERATIONS SHALL BE REMOVED AT THE CLOSE OF EACH WORKING DAY.
- THE EROSION CONTROL MEASURES INDICATED ON THE PLANS ARE THE MINIMUM REQUIREMENTS. ADDITIONAL MEASURES MAY BE REQUIRED, AS DIRECTED BY THE CLIENT OR OTHER JURISDICTIONAL GOVERNMENTAL ENTITIES.
- ALL EROSION AND SEDIMENTATION CONTROL MEASURES SHALL BE REMOVED AND DISPOSED OF IN ACCORDANCE WITH ALL JURISDICTIONAL GOVERNMENTAL AGENCY REQUIREMENTS WITHIN 30 DAYS OF FINAL STABILIZATION.

SOIL PROTECTION CHART

| STABILIZATION CHART | JAN | FEB | MAR | APR | MAY | JUN | JUL | AUG | SEP | OCT | NOV | DEC |
|---------------------|-----|-----|-----|-----|-----|-----|-----|-----|-----|-----|-----|-----|
| PERMANENT SEEDINGS | B | B | B | B | B | B | B | B | B | B | B | B |
| DORMANT SEEDINGS | | | | | | | | | | | | |
| TEMPORARY SEEDINGS | C | C | C | C | C | C | C | C | C | C | C | C |
| SODDING | | | | | | | | | | | | |
| MULCHING | F | F | F | F | F | F | F | F | F | F | F | F |

A - KENTUCKY BLUEGRASS 80 LBS/AC. MIXED WITH PERENNIAL RYEGRASS 20 LBS/AC.
 B - KENTUCKY BLUEGRASS 135 LBS/AC. MIXED WITH PERENNIAL RYEGRASS 45 LBS/AC. 2 TONS STRAW MULCH PER ACRE.
 C - SPRING OATS
 D - WHEAT OR CEREAL RYE
 E - SOD (NURSERY GROWN KENTUCKY BLUEGRASS)
 F - STRAW MULCH 2 TONS PER ACRE

* IRRIGATION NEEDED DURING JUNE, JULY AND SEPTEMBER
 ** IRRIGATION NEEDED FOR 2-3 WEEKS AFTER SODDING

NOTE: THIS CHART IS A GUIDE TO ASSIST THE CONTRACTOR IN UNDERSTANDING OPTIONS FOR SOIL STABILIZATION. THE LANDSCAPE PLAN SHALL TAKE PRECEDENCE OVER THIS CHART. ANY CONFLICT SHALL BE DISCUSSED WITH THE LANDSCAPE ARCHITECT PRIOR TO THE START OF CONSTRUCTION.

3 WORKING DAYS BEFORE YOU DIG CALL MISS-DIG® 1-800-482-7171



ALTERNATE NUMBER (248) MISS-DIG

COLOR CODES FOR UTILITY LOCATING:

| | | | |
|--------|---------------------|-------|-------------|
| Yellow | OIL & GAS | Blue | WATER |
| Orange | PHONE & CATV | Green | STORM DRAIN |
| Red | ELECTRIC | Brown | SEWER |
| White | PROPOSED EXCAVATION | Pink | SURVEYING |

IF YOU ARE GOING TO WORK NEAR OVERHEAD WIRES... CALL MISS DIG

"THESE EROSION CONTROL PLANS ARE A PORTION OF THE MICHIGAN ENVIRONMENT, GREAT LAKES, AND ENERGY (EGLE). TOTAL REQUIREMENTS FOR A COMPLETE STORMWATER POLLUTION PREVENTION PLAN (SWPPP) AS REQUIRED BY THE GENERAL NPDES PERMIT. CLIENT AND/OR CONTRACTOR WILL BE RESPONSIBLE FOR COMPLIANCE WITH ALL REQUIREMENTS OF THE GENERAL NPDES PERMIT AND COMPLETION OF THE COMPLETE SWPPP."

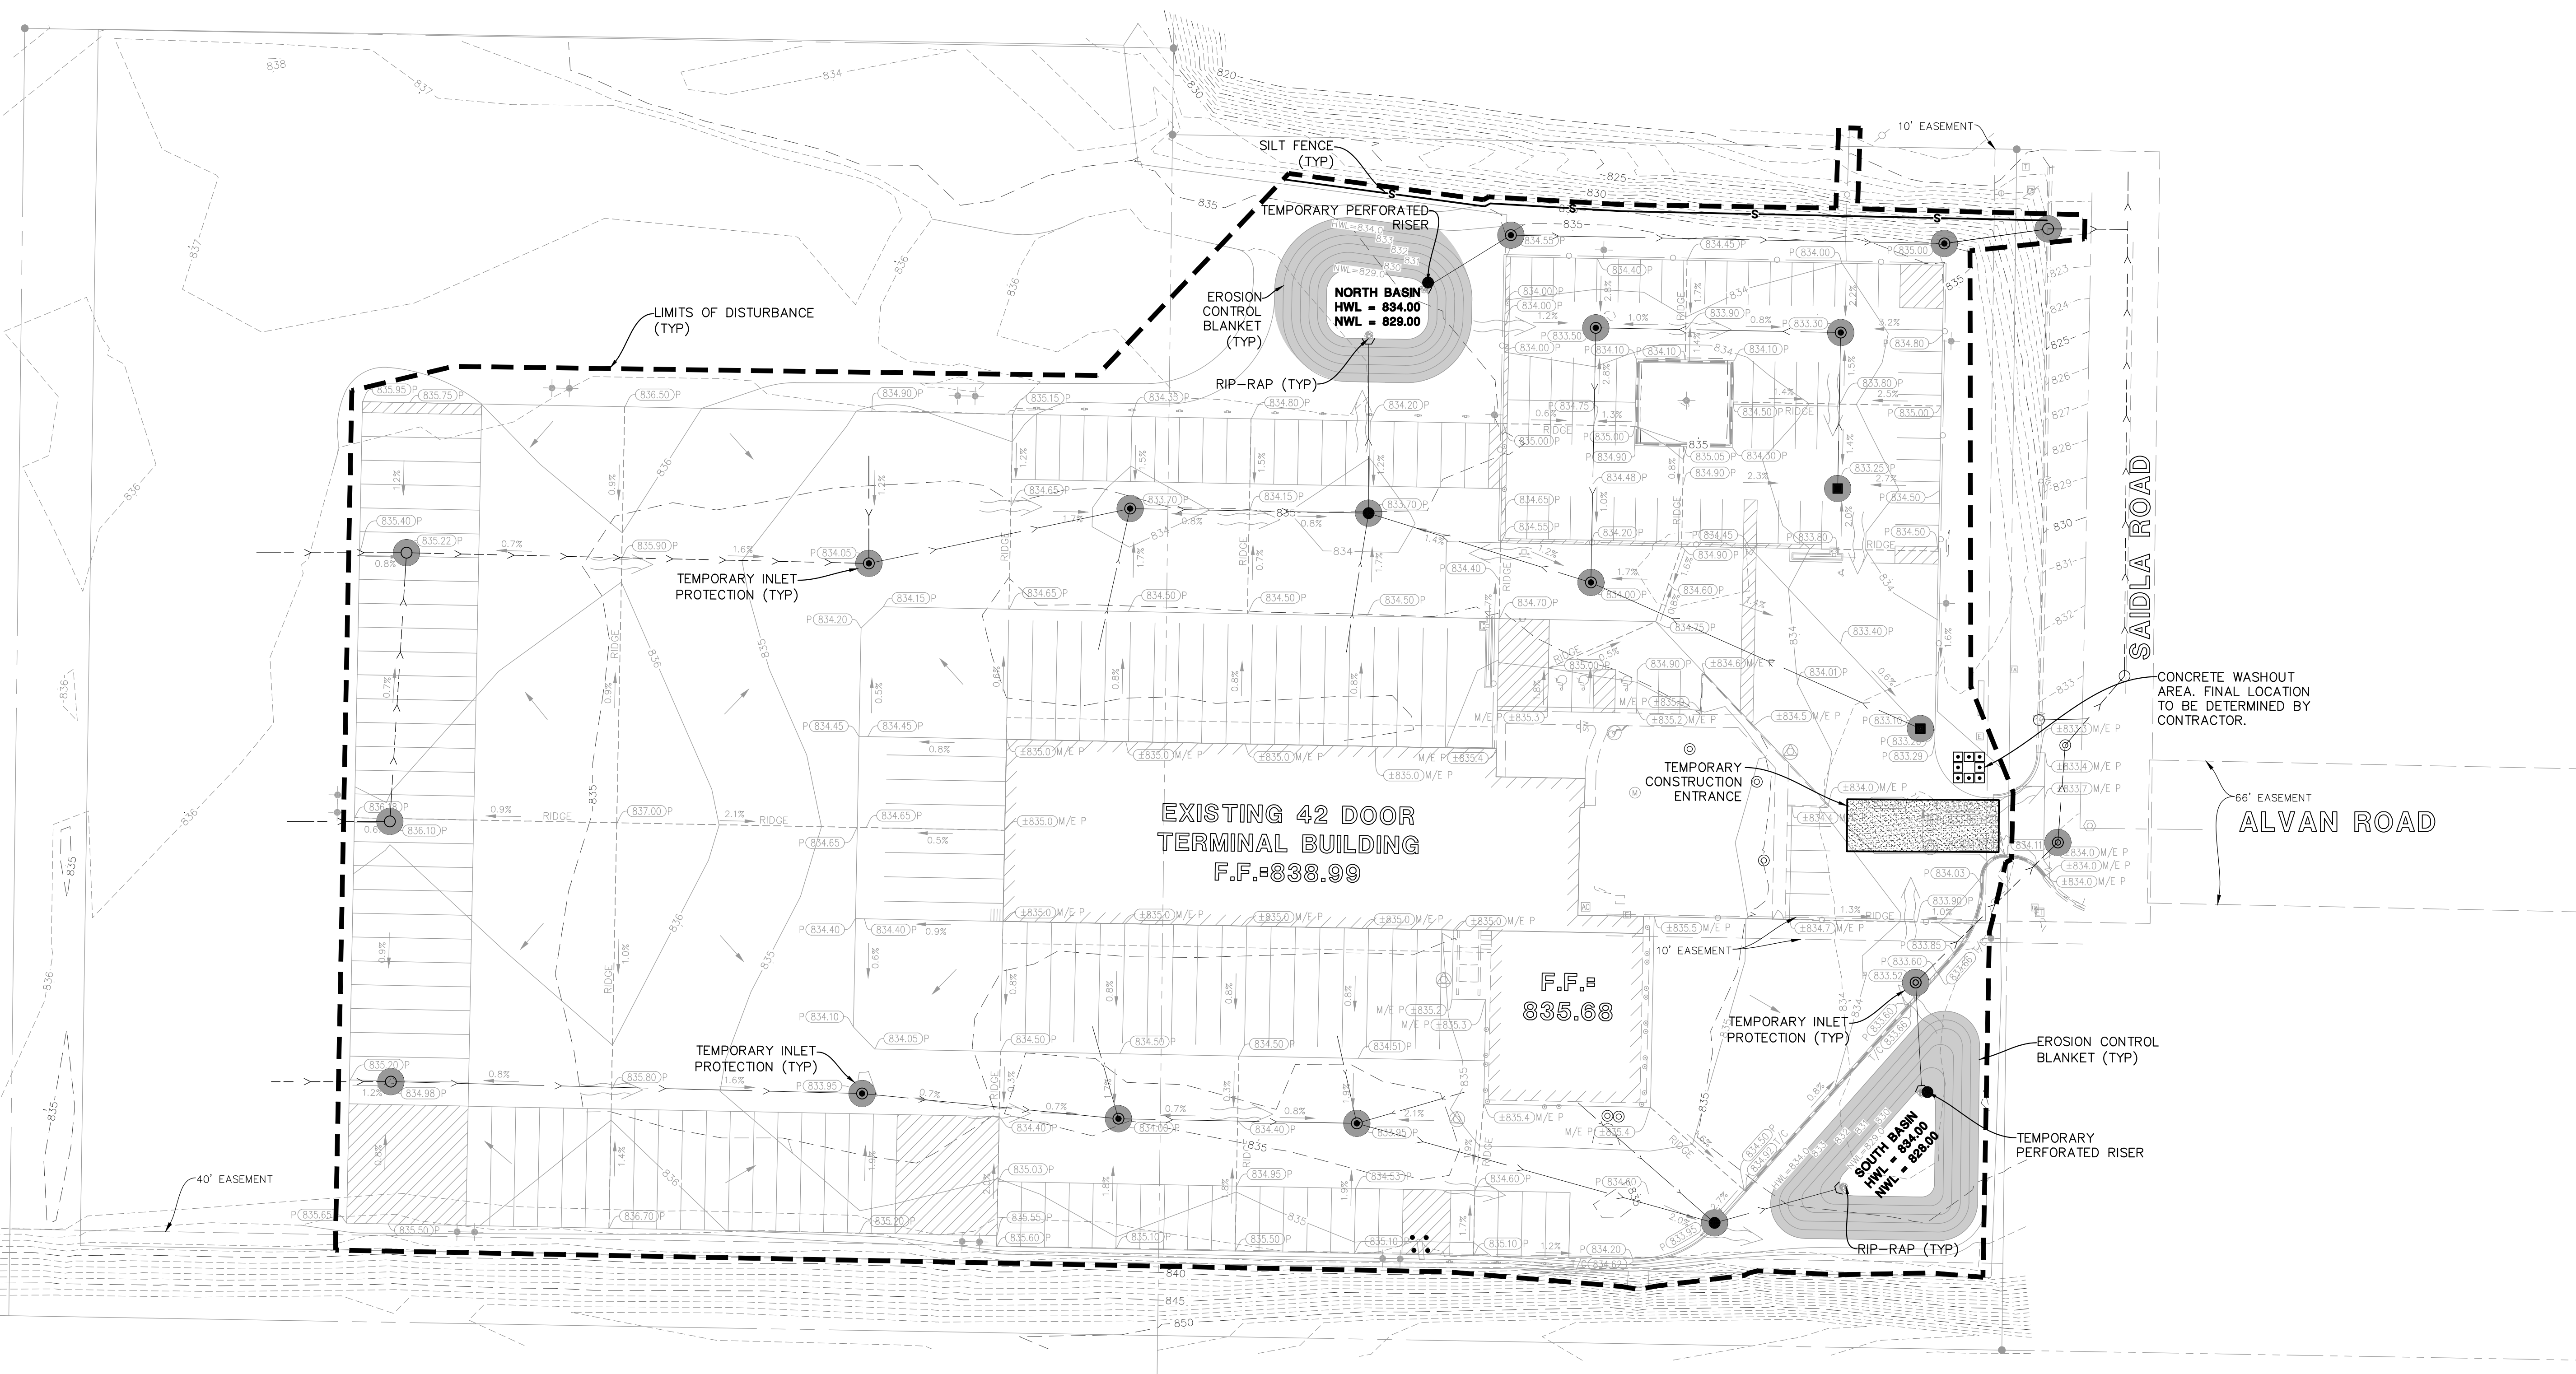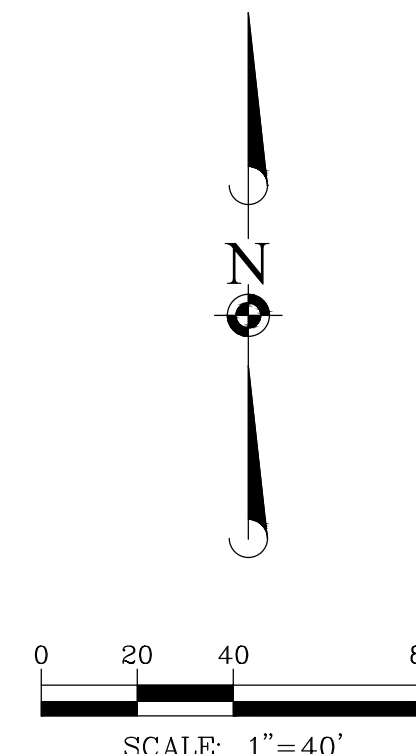

March 20, 2024 - 09:21. Draw Name: P:\04\kalam03\env\1\final\Drawings\Plan S41\Construction Document\SSSC.dwg. Updated By: Chamman

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 Construction Managers • Environmental Scientists • Landscape Architects • Planners








OLD DOMINION FREIGHT LINE - KALAMAZOO
CITY OF KALAMAZOO, MICHIGAN
SOIL EROSION AND SEDIMENT CONTROL PLAN

PROJ MGR: JAR
 PROJ ASSOC: A.H.
 DRAWN BY: ---
 DATE: 03/21/2024
 SCALE: 1"=40'

SHEET **3** OF **10**
 ODF.KAMI.01

PENDING APPROVAL - NOT FOR CONSTRUCTION

March 21, 2024 - 17:14 Day Name: P:\04\kalam01\env\Task\Drawings\Plan\541\Construction Documents\SPEC\DETAILS.dwg Updated By: Chimon

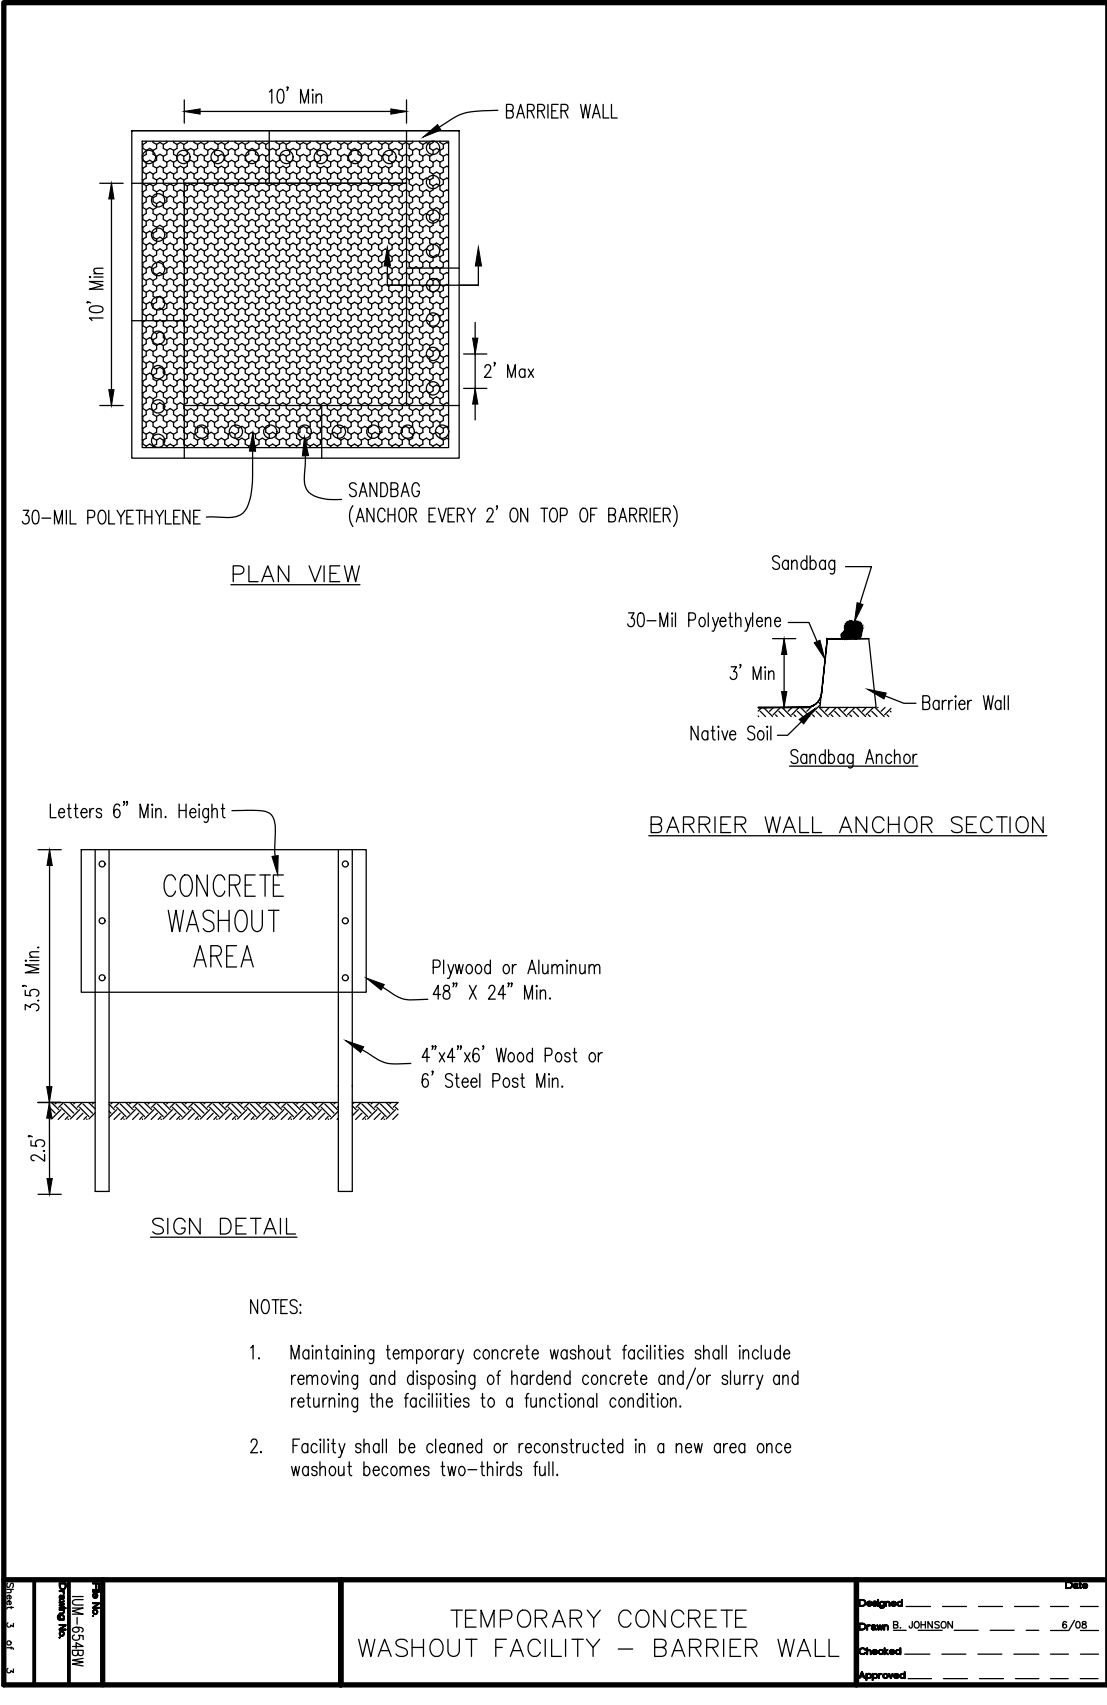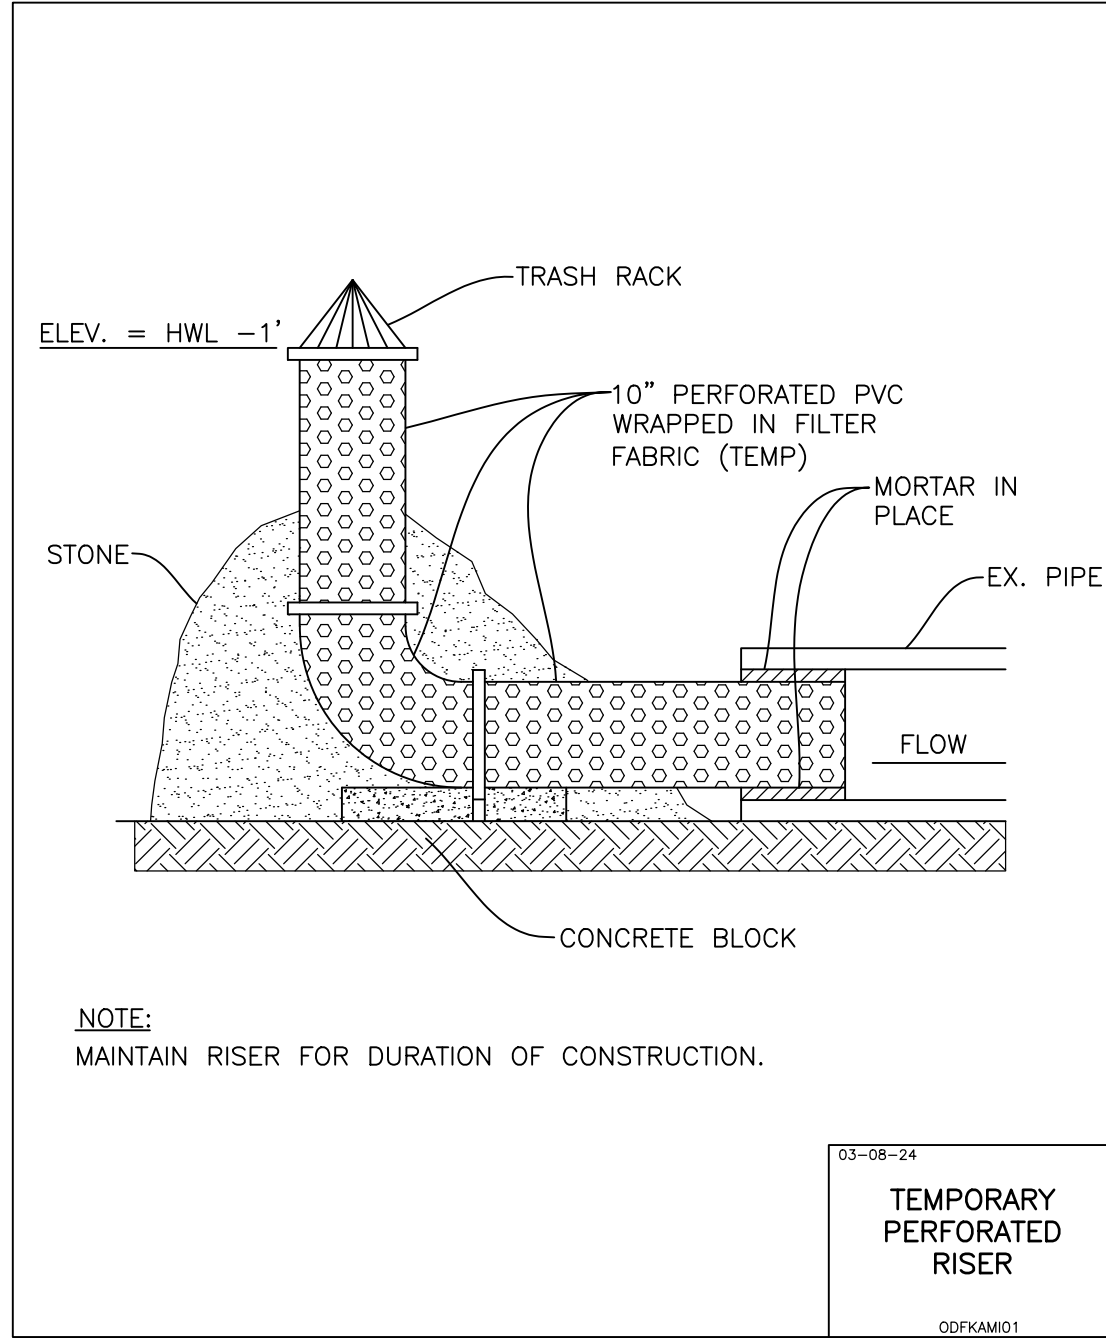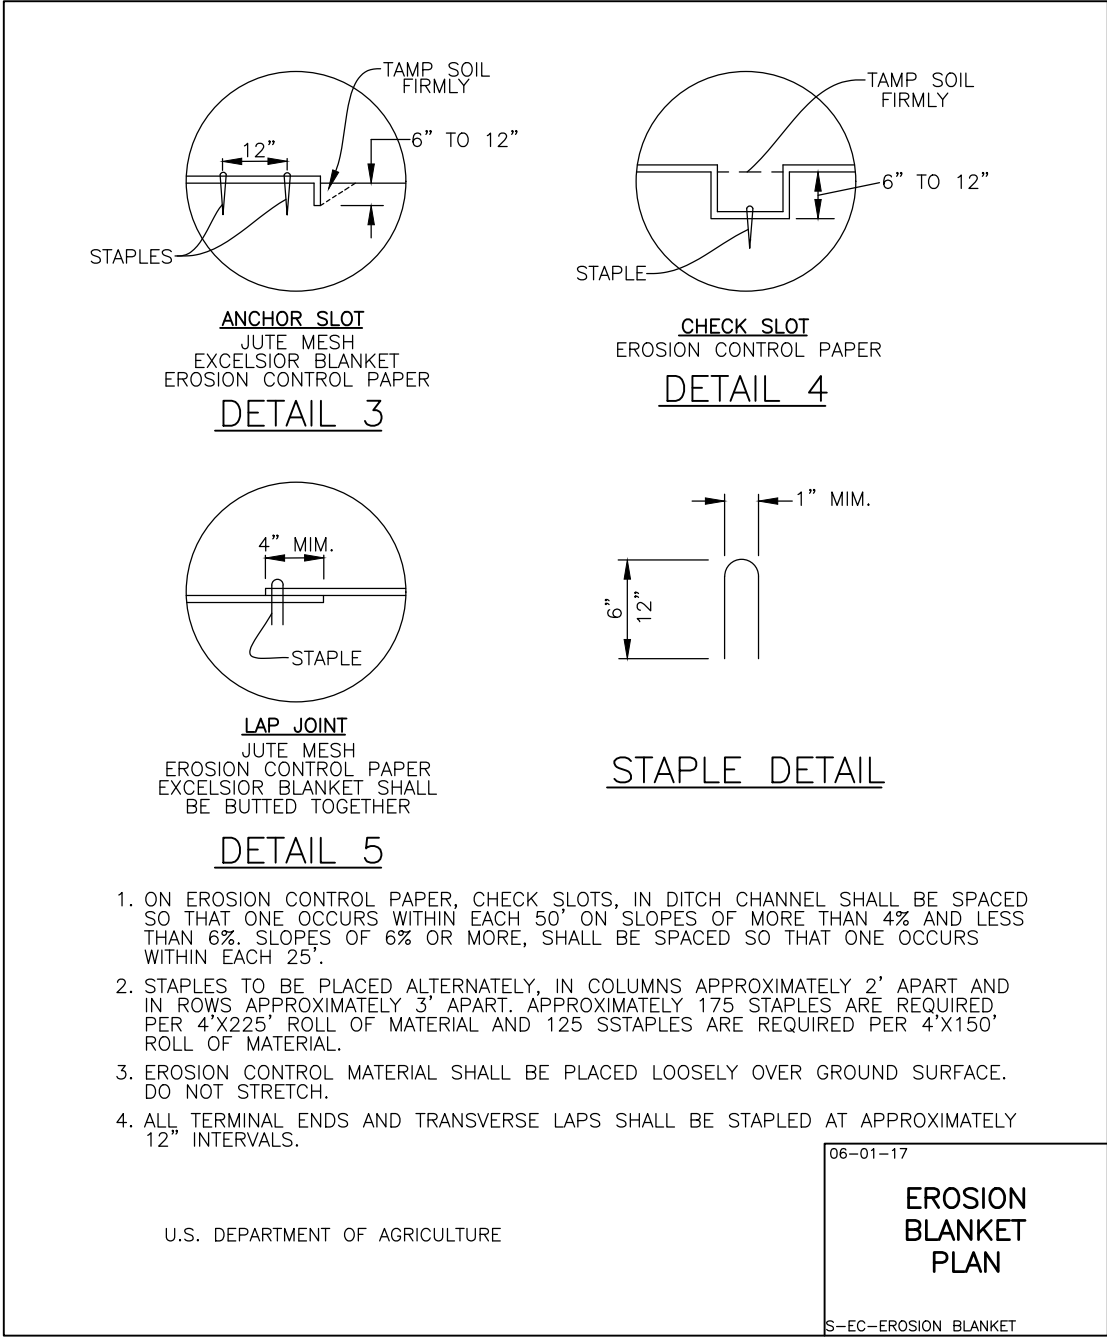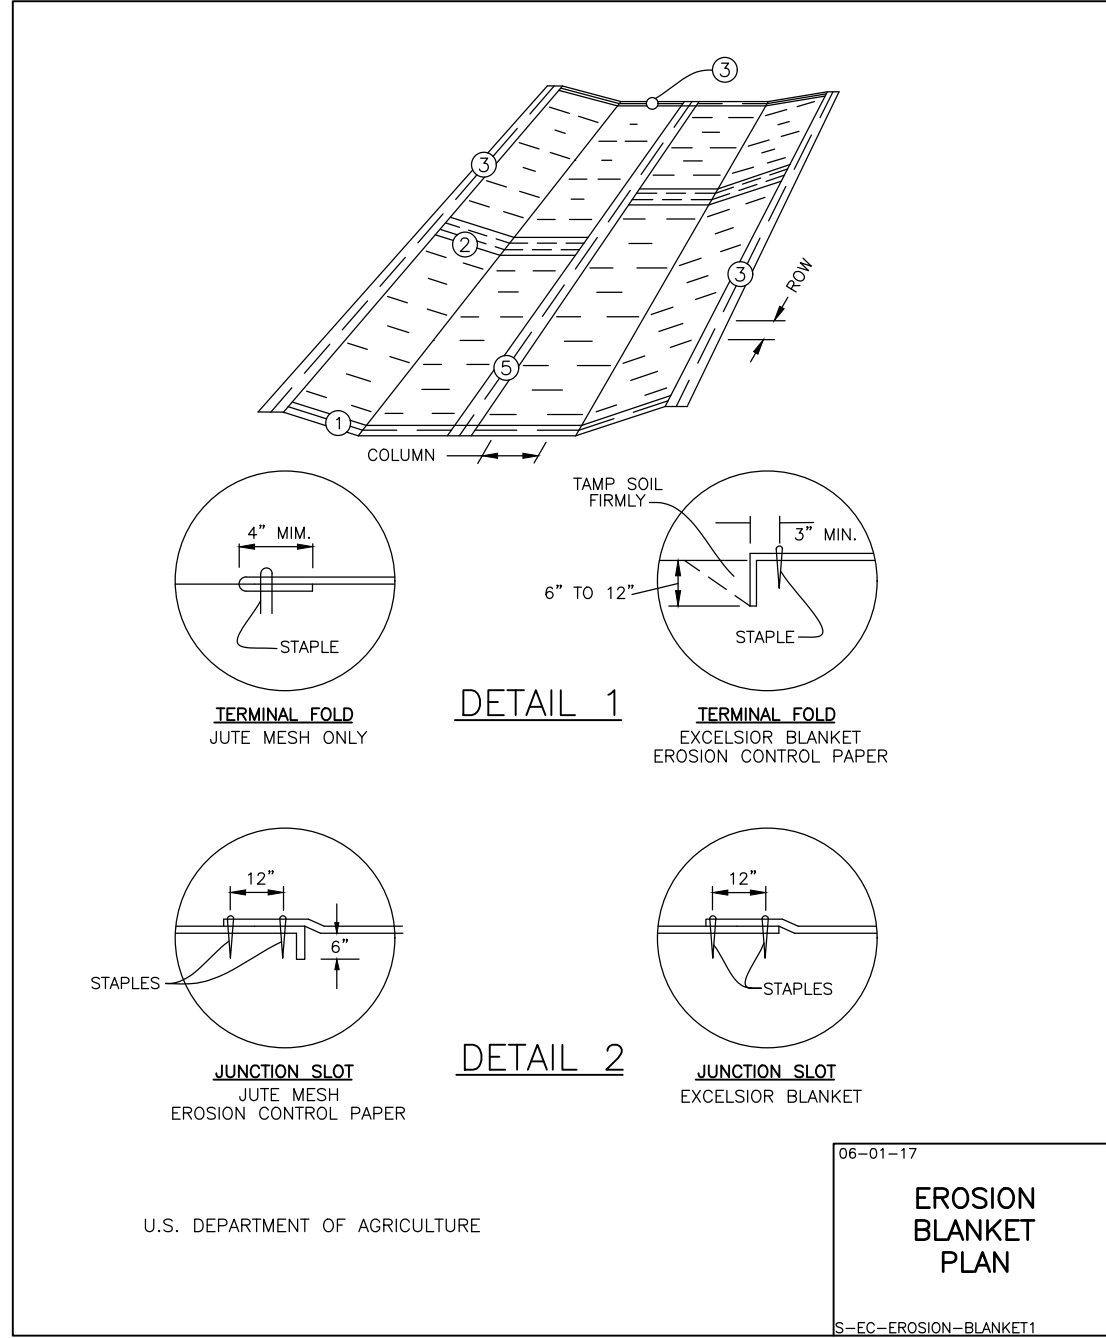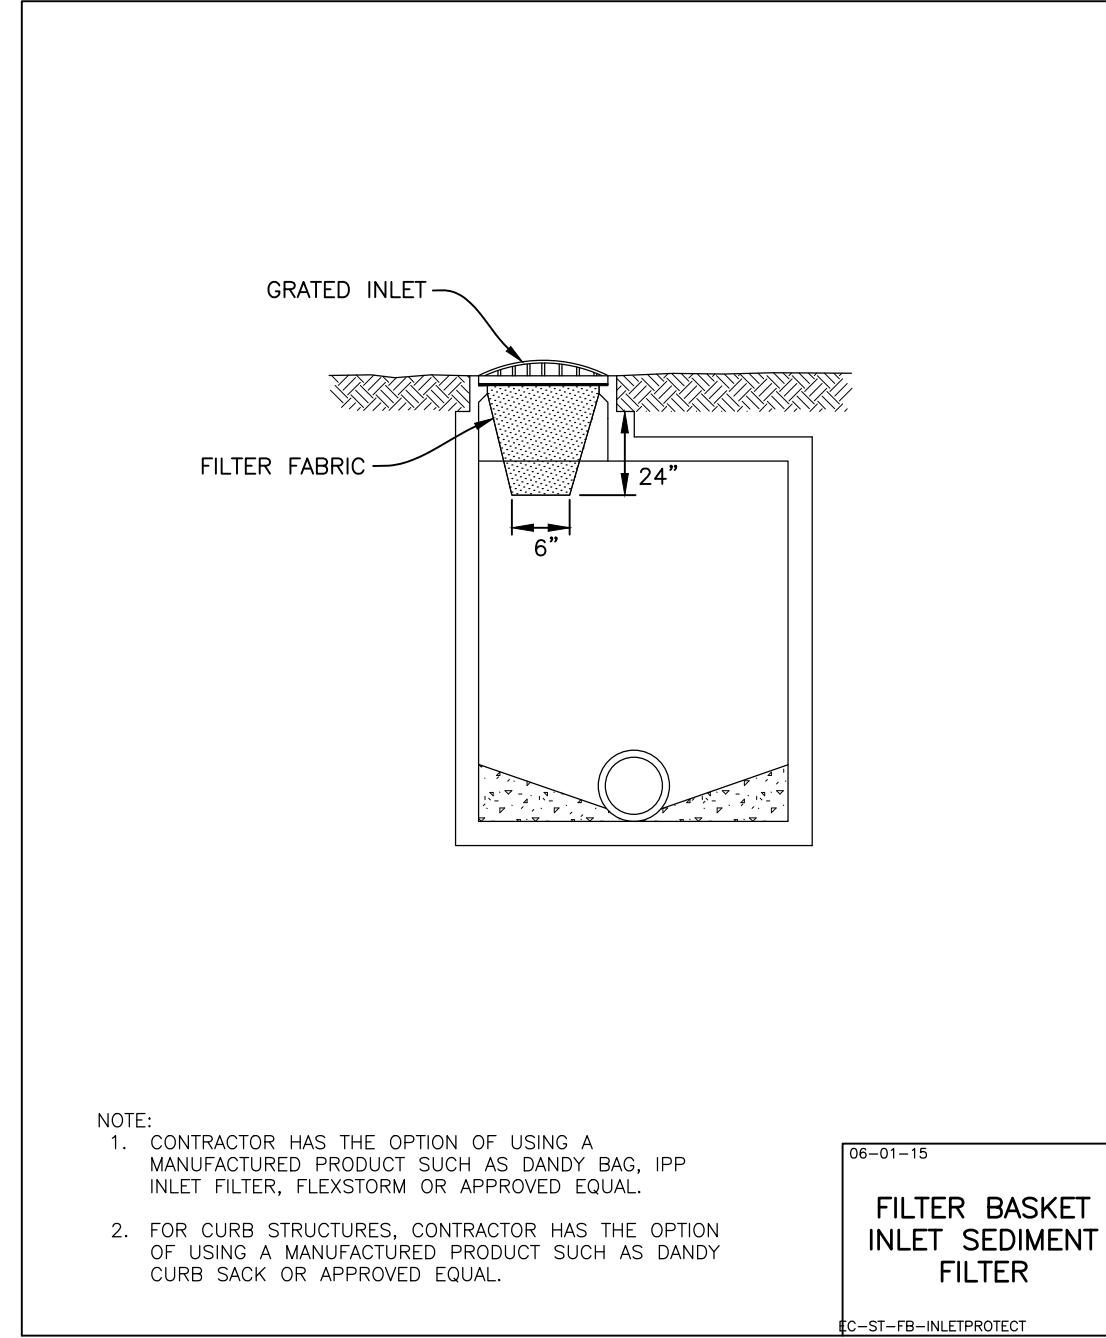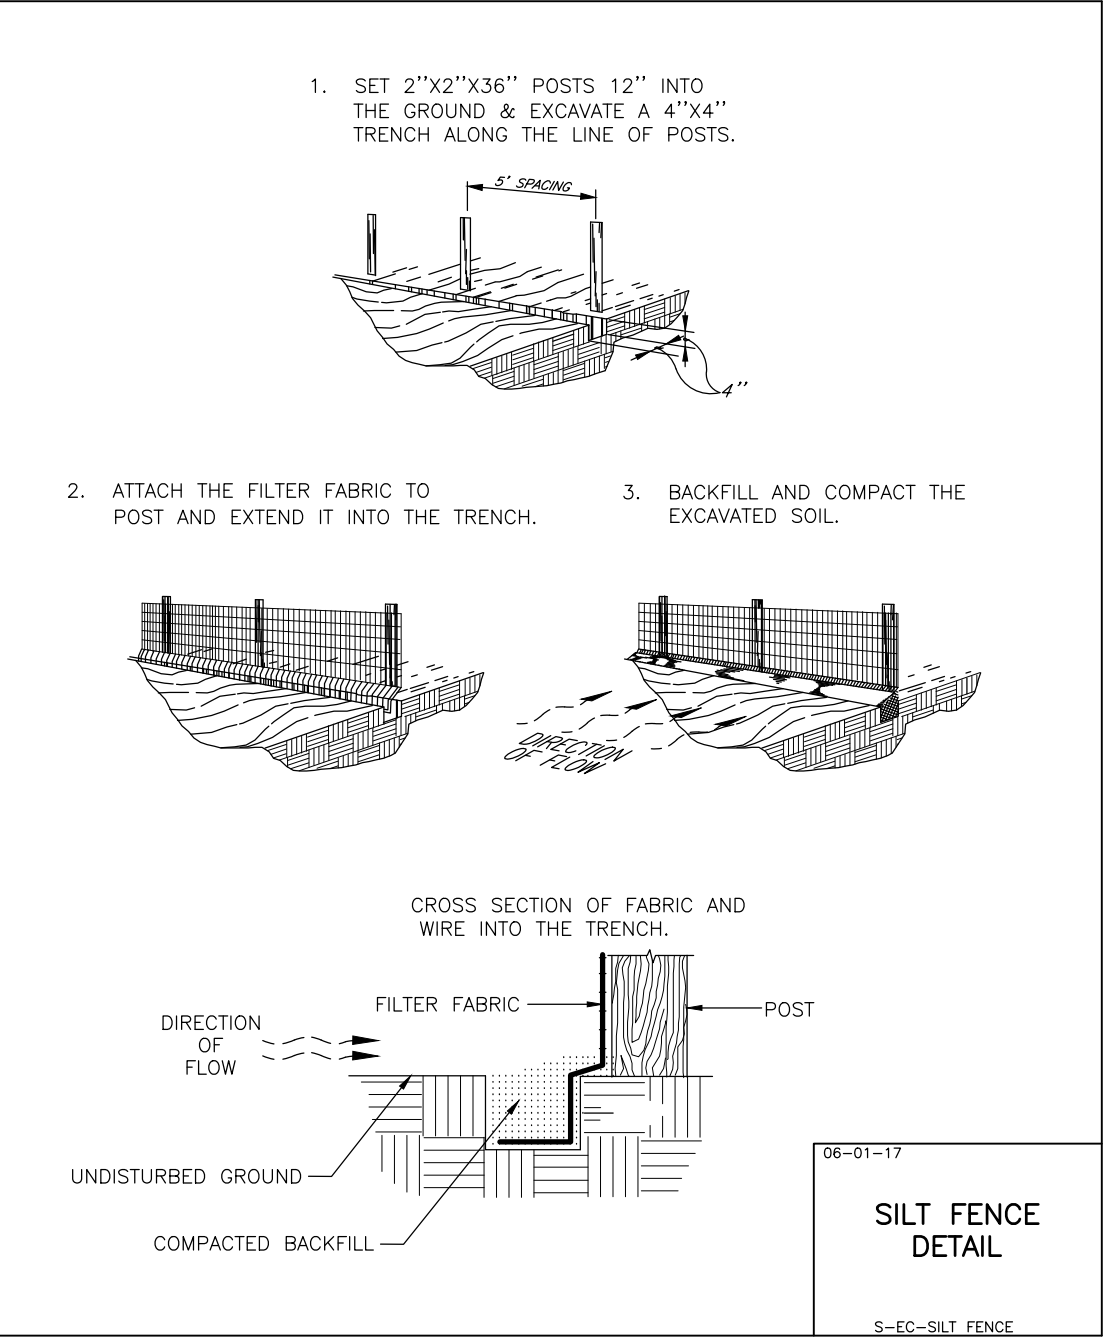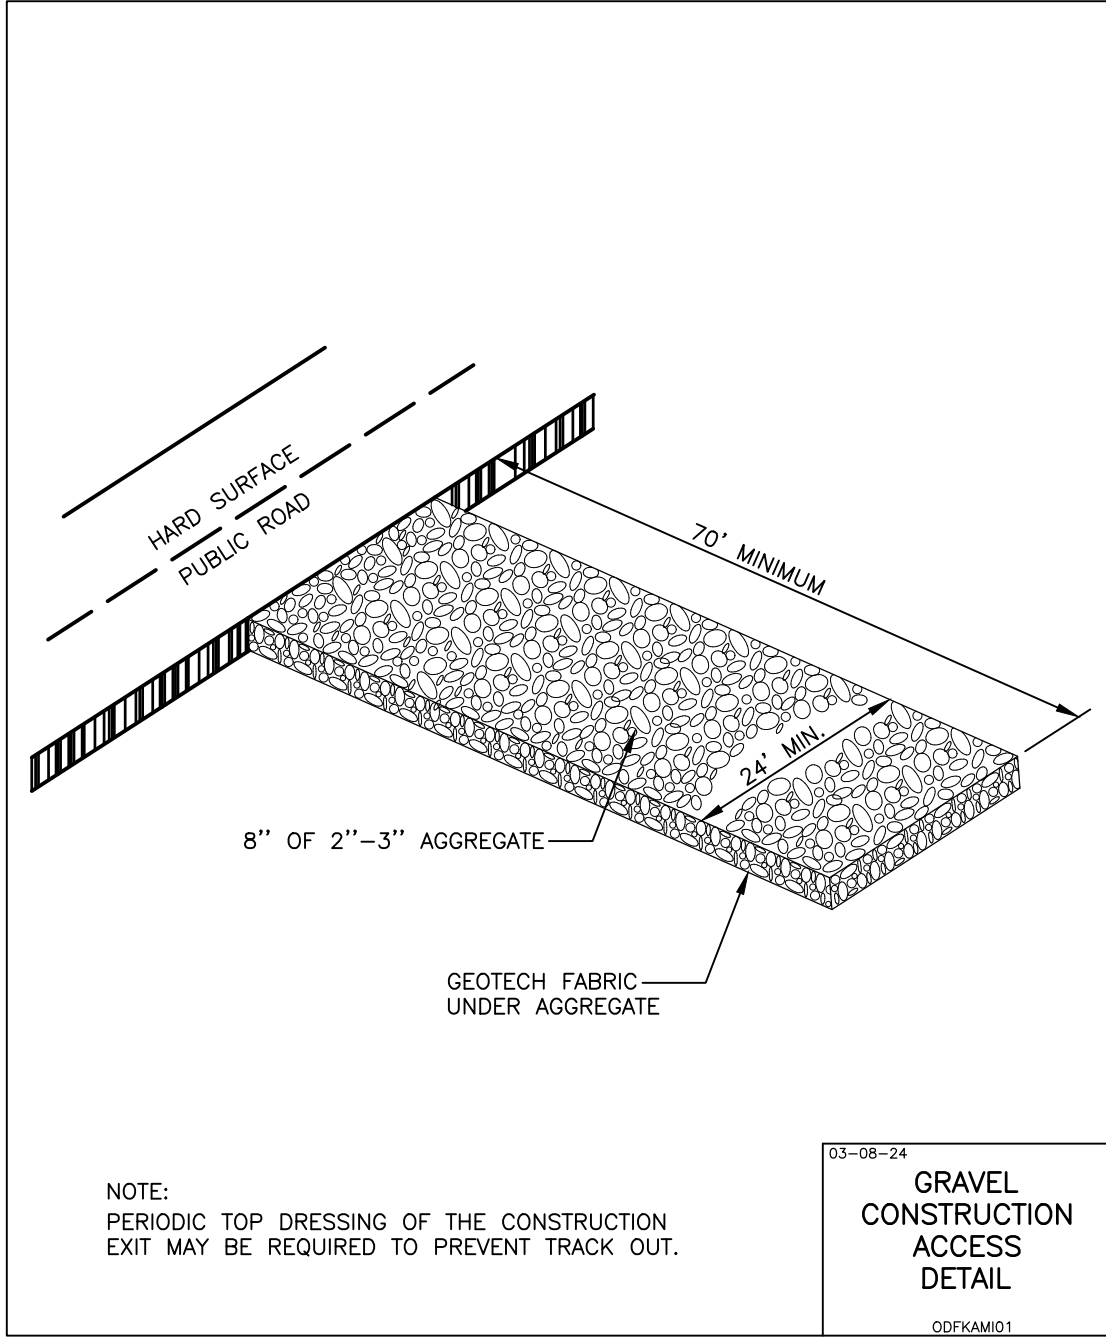

SHOULD A CONFLICT ARISE BETWEEN MANHARD DETAILS AND THE VILLAGE DETAILS, THE VILLAGE DETAILS SHALL TAKE PRECEDENCE.

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Manhard CONSULTING
 300 East River Street, Suite 200, Kalamazoo, MI 49001
 269.399.2500
 www.manhardconsulting.com
 Civil Engineers • Surveyors • Water Resource Engineers • Water & Wastewater Engineers
 Construction Managers • Environmental Scientists • Landscape Architects • Planners

OLD DOMINION FREIGHT LINE - KALAMAZOO
CITY OF KALAMAZOO, MICHIGAN
SOIL EROSION AND SEDIMENT CONTROL DETAILS

PROJ. MGR.: JAR
 PROJ. ASSOC.: AJH
 DRAWN BY: ALM
 DATE: 03/21/2024
 SCALE: N.T.S.

SHEET
4 OF 10
 ODF.KAMI.01



PENDING APPROVAL - NOT FOR CONSTRUCTION

| NORTH DETENTION BASIN | |
|-----------------------|------------|
| HWL | 834.00 |
| NWL | 829.00 |
| DET. VOLUME PROVIDED | 0.36 AC-FT |

| SOUTH DETENTION BASIN | |
|-----------------------|------------|
| HWL | 834.00 |
| NWL | 829.00 |
| DET. VOLUME PROVIDED | 0.45 AC-FT |

| GRADING PLAN LEGEND | |
|---------------------|-----------------------------------------------------------|
| | PROPOSED 1 FOOT CONTOURS |
| | PROPOSED SPOT ELEVATION |
| | PROPOSED FINISHED FLOOR ELEVATION |
| | PROPOSED GRADE AT FOUNDATION |
| | PROPOSED PAVEMENT ELEVATION |
| | PROPOSED TOP OF CURB |
| | PROPOSED TOP OF WALK |
| | PROPOSED TOP OF WALL |
| | MEET EXISTING |
| | PROPOSED GROUND GRADE OR GROUND AT BASE OF RETAINING WALL |
| | PROPOSED DITCH OR SWALE |
| | PROPOSED DIRECTION OF FLOW |
| | OVERFLOW RELIEF SWALE |
| | PROPOSED RIDGE LINE |
| | PROPOSED DEPTH OF PONDING |
| | RETAINING WALL |
| | PROPOSED SWALE LOW POINT |
| | PROPOSED SWALE SUMMIT |

- GRADING NOTES:**
- RETAINING WALL DESIGN TO BE PROVIDED BY OTHERS.
 - PAVING SLOPES THROUGH HANDICAP ACCESSIBLE PARKING AREAS SHALL BE 2.00% MAXIMUM IN ANY DIRECTION.
 - ALL HANDICAP RAMPS SHALL BE CONSTRUCTED WITH A MAXIMUM CROSS SLOPE OF 2.00% OR LESS.
 - MEET EXISTING GRADE AT PROPERTY LIMITS UNLESS NOTED OTHERWISE.
 - CONTRACTOR SHALL REFER TO THE SOIL EROSION AND SEDIMENT CONTROL PLAN AND DETAILS FOR CONSTRUCTION SCHEDULING AND EROSION CONTROL MEASURES TO BE INSTALLED PRIOR TO BEGINNING GRADING OPERATIONS.
 - THE CONTRACTOR SHALL CONTACT MISS-DIG (1-800-482-7171) 3 WORKING DAYS PRIOR TO ANY WORK TO LOCATE UTILITIES AND SHALL CONTACT THE OWNER SHOULD UTILITIES APPEAR TO BE IN CONFLICT WITH THE PROPOSED IMPROVEMENT.
 - THE CONTRACTOR IS SPECIFICALLY CAUTIONED THAT THE LOCATION AND/OR ELEVATION OF EXISTING UTILITIES AS SHOWN ON THESE PLANS IS BASED ON RECORDS OF THE VARIOUS UTILITY COMPANIES, AND WHERE POSSIBLE, MEASUREMENTS TAKEN IN THE FIELD. THE INFORMATION IS NOT TO BE RELIED ON AS BEING EXACT OR COMPLETE. THE CONTRACTOR MUST CALL THE APPROPRIATE UTILITY COMPANIES AT LEAST 72 HOURS BEFORE ANY EXCAVATION TO REQUEST EXACT FIELD LOCATION OF UTILITIES. IT SHALL BE THE RESPONSIBILITY OF THE CONTRACTOR TO RELOCATE ALL EXISTING UTILITIES WHICH CONFLICT WITH THE PROPOSED IMPROVEMENTS SHOWN ON THE PLANS.
 - IF ANY EXISTING STRUCTURES TO REMAIN ARE DAMAGED DURING CONSTRUCTION IT SHALL BE THE CONTRACTORS RESPONSIBILITY TO REPAIR AND/OR REPLACE THE EXISTING STRUCTURE AS NECESSARY TO RETURN IT TO EXISTING CONDITION OR BETTER.
 - ALL UNPAVED AREAS DISTURBED BY GRADING OPERATIONS SHALL RECEIVE 6 INCHES OF TOPSOIL. CONTRACTOR SHALL APPLY STABILIZATION FABRIC TO ALL SLOPES 3H:1V OR STEEPER. CONTRACTOR SHALL STABILIZE DISTURBED AREAS IN ACCORDANCE WITH GOVERNING SPECIFICATIONS UNTIL A HEALTHY STAND OF VEGETATION IS OBTAINED.
 - EXISTING TOPOGRAPHY SHOWN REPRESENTS SITE CONDITIONS AS PREPARED BY NEDERVELD ON OCTOBER 2023. CONTRACTOR SHALL FIELD CHECK EXISTING ELEVATIONS AND CONDITIONS PRIOR TO CONSTRUCTION AND NOTIFY ARCHITECT AND ENGINEER OF ANY DISCREPANCIES PRIOR TO STARTING CONSTRUCTION. IF THE CONTRACTOR DOES NOT ACCEPT EXISTING TOPOGRAPHY AS SHOWN ON THE PLANS, WITHOUT EXCEPTION, THEN THE CONTRACTOR SHALL SUPPLY, AT THEIR EXPENSE, A TOPOGRAPHIC SURVEY BY A REGISTERED LAND SURVEYOR TO THE OWNER FOR REVIEW.
 - TRANSITIONS FROM DEPRESSED CURB TO FULL HEIGHT CURB SHALL BE TAPERED AT 2H:1V UNLESS OTHERWISE NOTED.

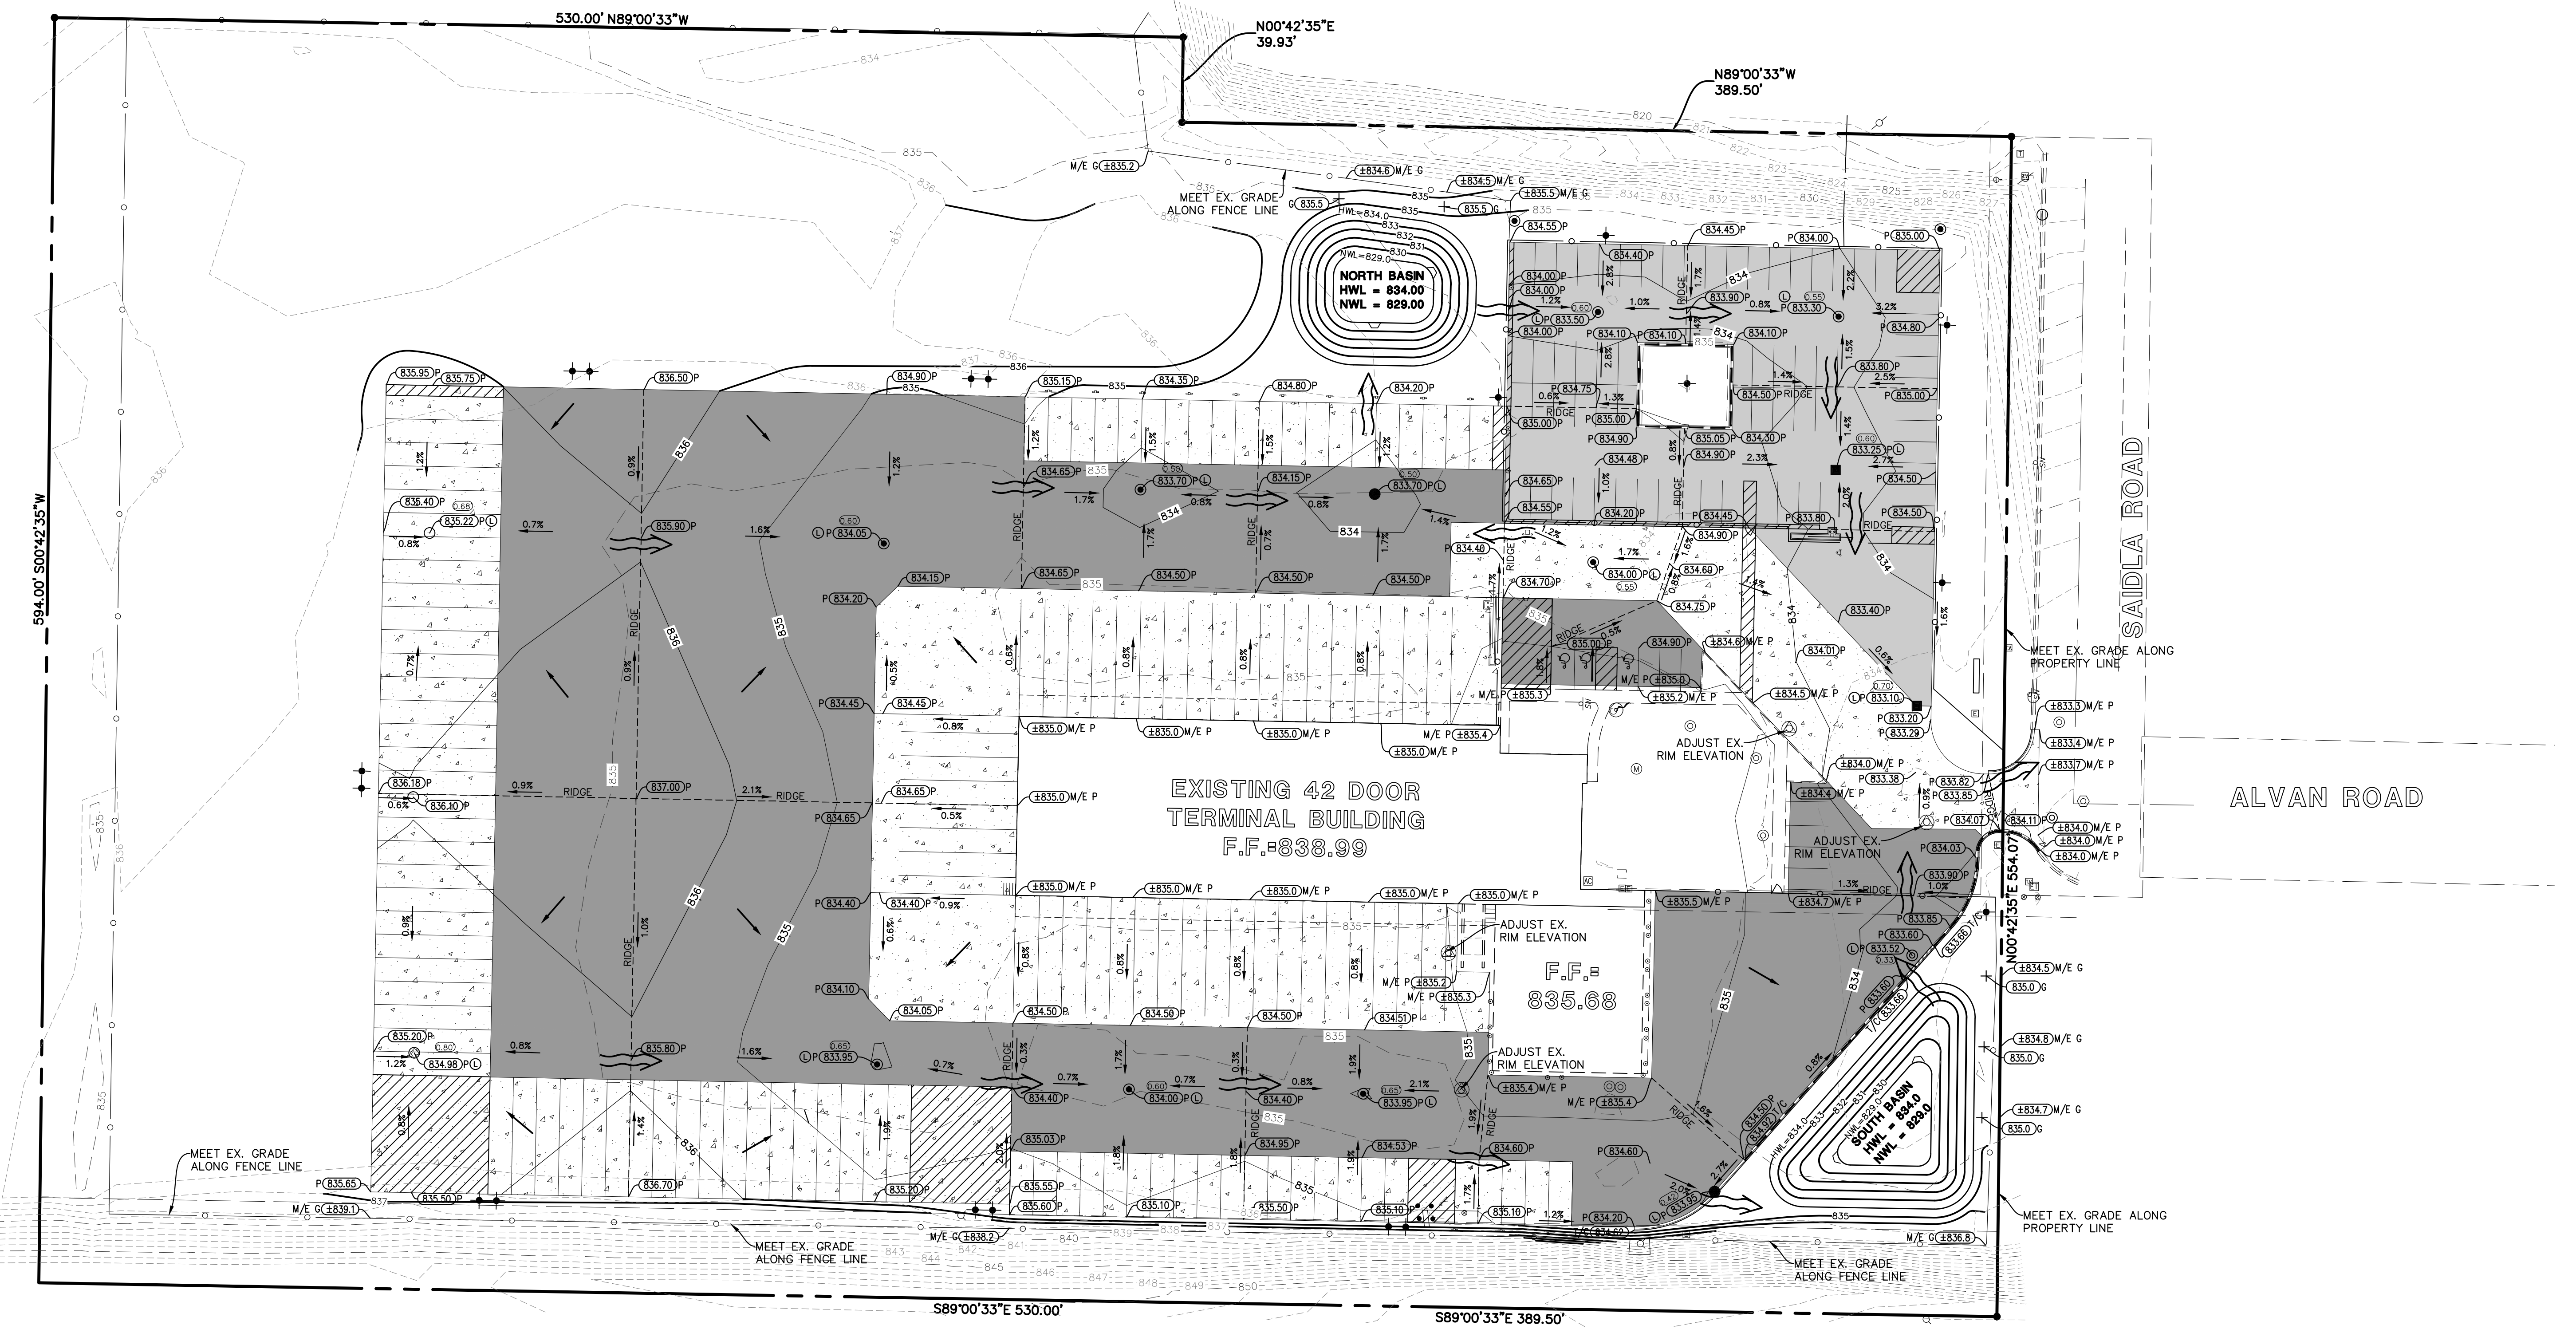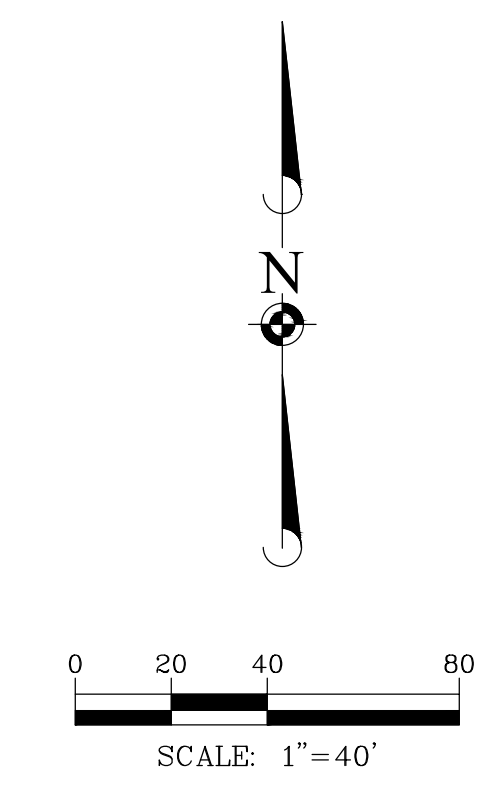

| NO. | DATE | REVISIONS |
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OLD DOMINION FREIGHT LINE - KALAMAZOO
 CITY OF KALAMAZOO, MICHIGAN
GRADING PLAN

PROJ. MGR.: JAR
 PROJ. ASSOC.: ALH
 DRAWN BY: CLH
 DATE: 03/21/2024
 SCALE: 1"=40'

SHEET
6 OF 10
 ODF.KAMI.01

PENDING APPROVAL - NOT FOR CONSTRUCTION

March 20, 2024, 10:22 AM - Draw Name: P:\03\Kalamazoo\03\Final\Drawings\Plan\541\Construction\Documents\GRADING.PLAN.dwg, Updated By: Channon


PRELIMINARY ENGINEERING PLANS for OLD DOMINION FREIGHT LINE KALAMAZOO

3600 ALVAN ROAD
CITY OF KALAMAZOO, MICHIGAN


| DATE | REVISIONS | DRAWN BY |
|------------|-----------|----------|
| 03/27/2024 | REVISION | JSH |
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|--------------|-----------|
| PROJ. MGR. | JAR |
| PROJ. ASSOC. | |
| DRAWN BY | JSH |
| DATE | 2/12/2024 |
| SCALE | AS SHOWN |
| SHEET | |
| L1 OF L3 | |
| ODF.KAMI01 | |

Manhard CONSULTING
 505 East Southfield Road, Suite 200, Farmington Hills, MI 48334
 Tel: 248.316.0000 Fax: 248.316.0001
 Website: www.manhardconsulting.com
 Construction Management • Planning
 Civil Engineers • Surveyors • Water Resources Engineers • Wetland & Wetwater Engineers
 Environmental Scientists • Landscape Architects • Planners

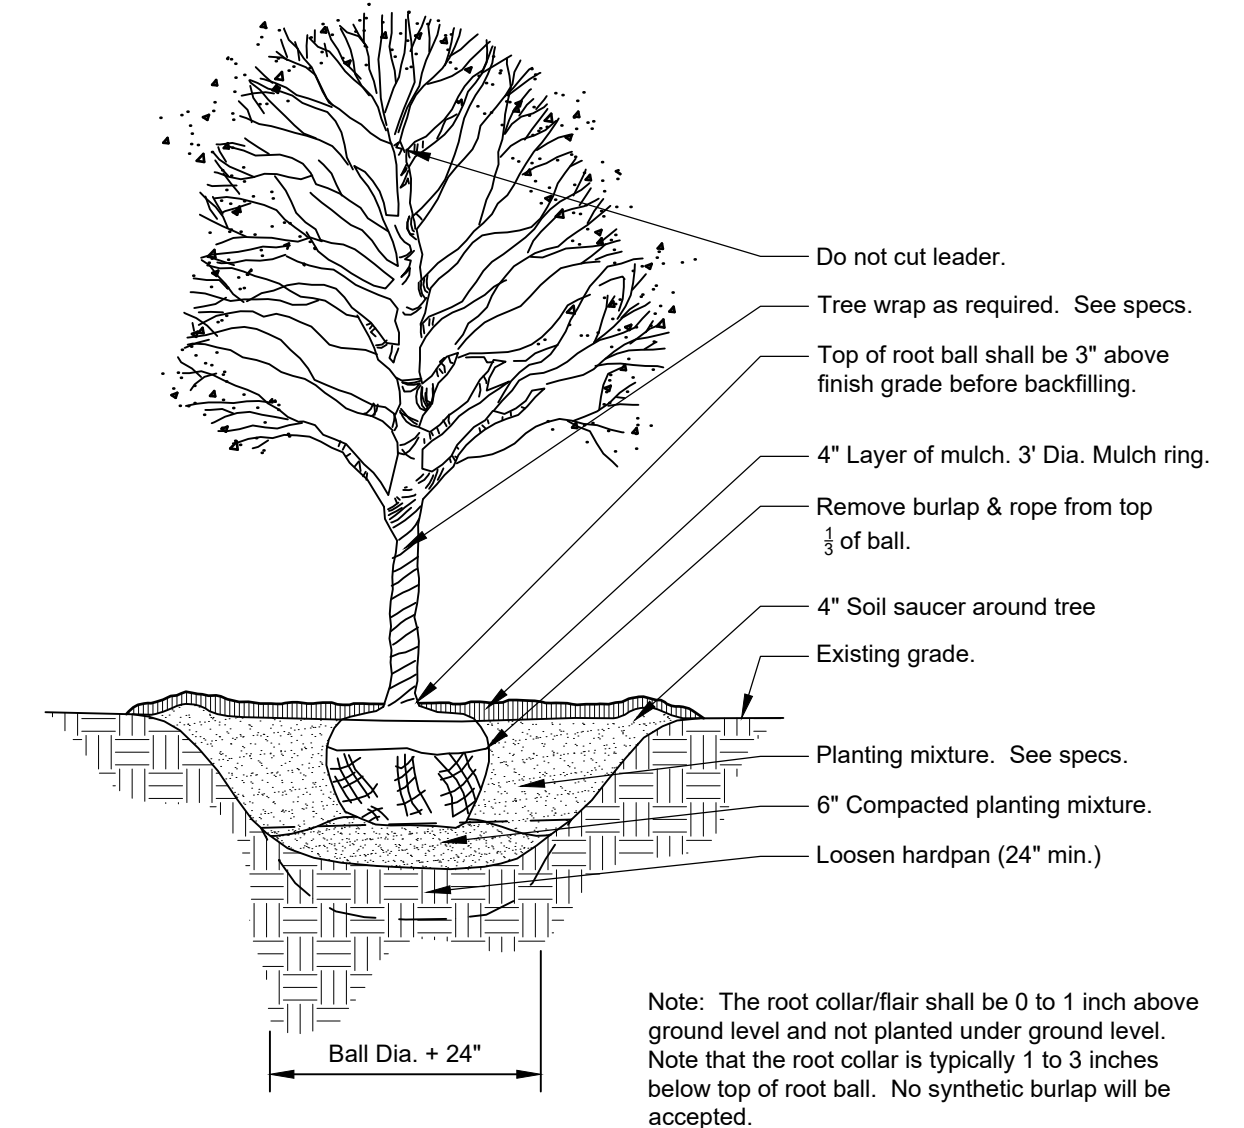

1 DECIDUOUS TREE PLANTING
 1/4" = 1'-0" 32 9343.33-20

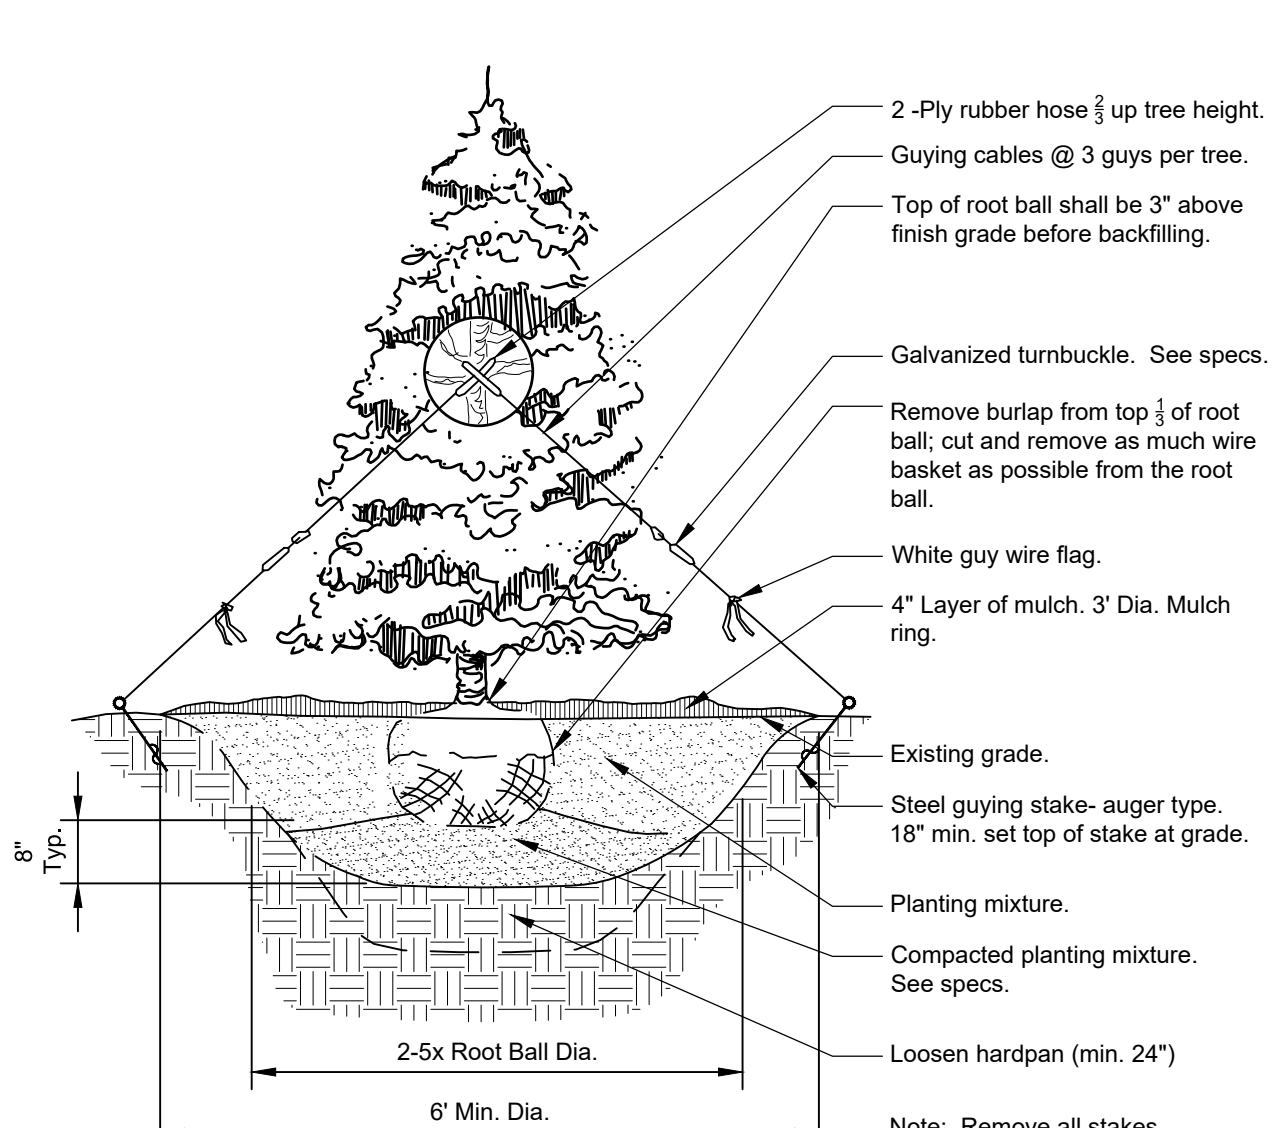

2 CONIFER TREE PLANTING
 1/4" = 1'-0" 32 9343.46-01

City of Kalamazoo Required Landscaping

Site is not in Natural Features Protection Overlay District. Overlay District requirements not applicable. (Sec.50-6.2)
 No adjacent conflicting land uses. No buffer/screening required per ordinance. City planner reserves the right to select additional screening per Section 6.2.H.5.

Required Vehicular Off-Street Parking Areas (Sec.50-7.2(f))

Areas not used for sidewalks, parking spaces, drive aisles, loading, or refuse shall be constructed and maintained as landscaped areas.
 The perimeter of a parking lot shall be treated with fencing and/or landscaping along all property lines following Appendix A, 6.2, Landscaping and Open Spaces.
 Parking lots with more than two double-loaded aisles will provide internal pedestrian access. The pathway shall be buffered from drive aisles with landscaping or designated parking stalls and delineated with paint where it crosses drive aisles. **On Plan: Employee parking is existing and will remain.**

Landscaping and Open Spaces (Appendix Zoning Ordinance 6.2)


No one species of tree or shrub may make up more than 50% of the total amount of landscape plantings, except for plantings used for screening.
 In all areas where landscaping is required, a minimum of 50% of the surface area shall be covered by living materials.

- Minimum sizes of plant materials:
- Deciduous canopy tree: 2-2.5" caliper
 - Evergreen tree: 6' height
 - Deciduous shrub: 30" height
 - Upright evergreen shrub: 30" height
 - Spreading evergreen shrub: 24" spread
 - Deciduous ornamental tree: 1-1.5" caliper / 6' height


Buffer Areas:
 Between land uses, plant materials shall not be placed closer than 4' from the fence or property line. **On Plan: No adjacent differing land uses.**

City Right-Of-Way:
 Tree removal or planting in City ROW shall be in accordance with Chapter 42 of City ordinances, and public ROW shall be grass-surfaced. **Any trees in ROW shall be preserved.**

Preservation of Existing Screening:
 Regardless of the other provisions under this subsection, existing trees, vegetation, other natural features, and other screening components such as walls, berms, and fences that are located within the required setback of the site, that are healthy or otherwise in good condition, and that provide, in the opinion of the City Planner, an important measure of screening for adjacent properties shall be preserved. When a property is required to provide buffering/screening under the regulations in § 6.2, a site plan shall be provided that identifies all existing trees of 10 inches or greater in diameter measured at breast height located throughout the entire site and which of those trees will be removed; any existing healthy trees in good condition shall only be removed on a showing of good cause. **On Plan: Screening is not**

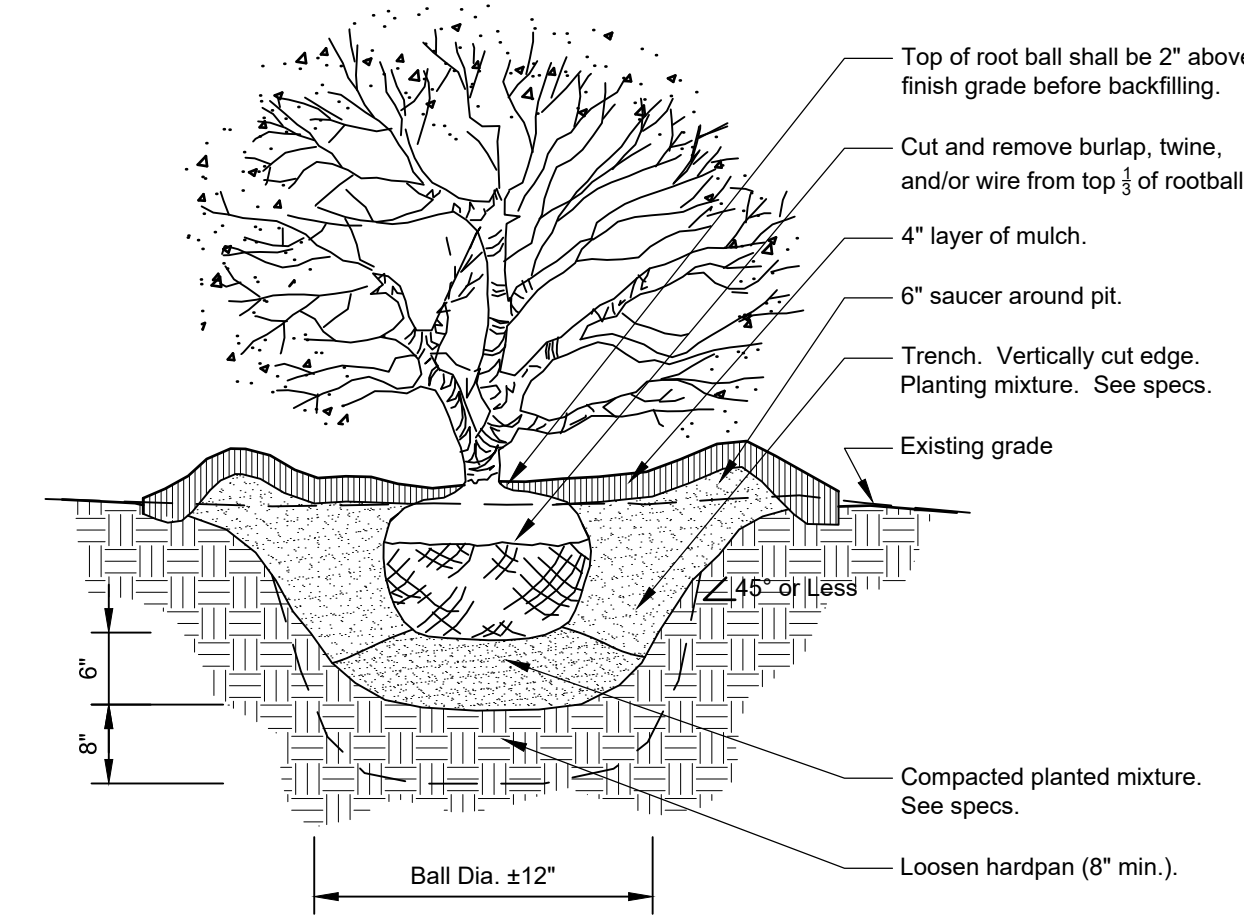

3 SHRUB PLANTING DETAIL
 3/4" = 1'-0" 32 9333.16-05

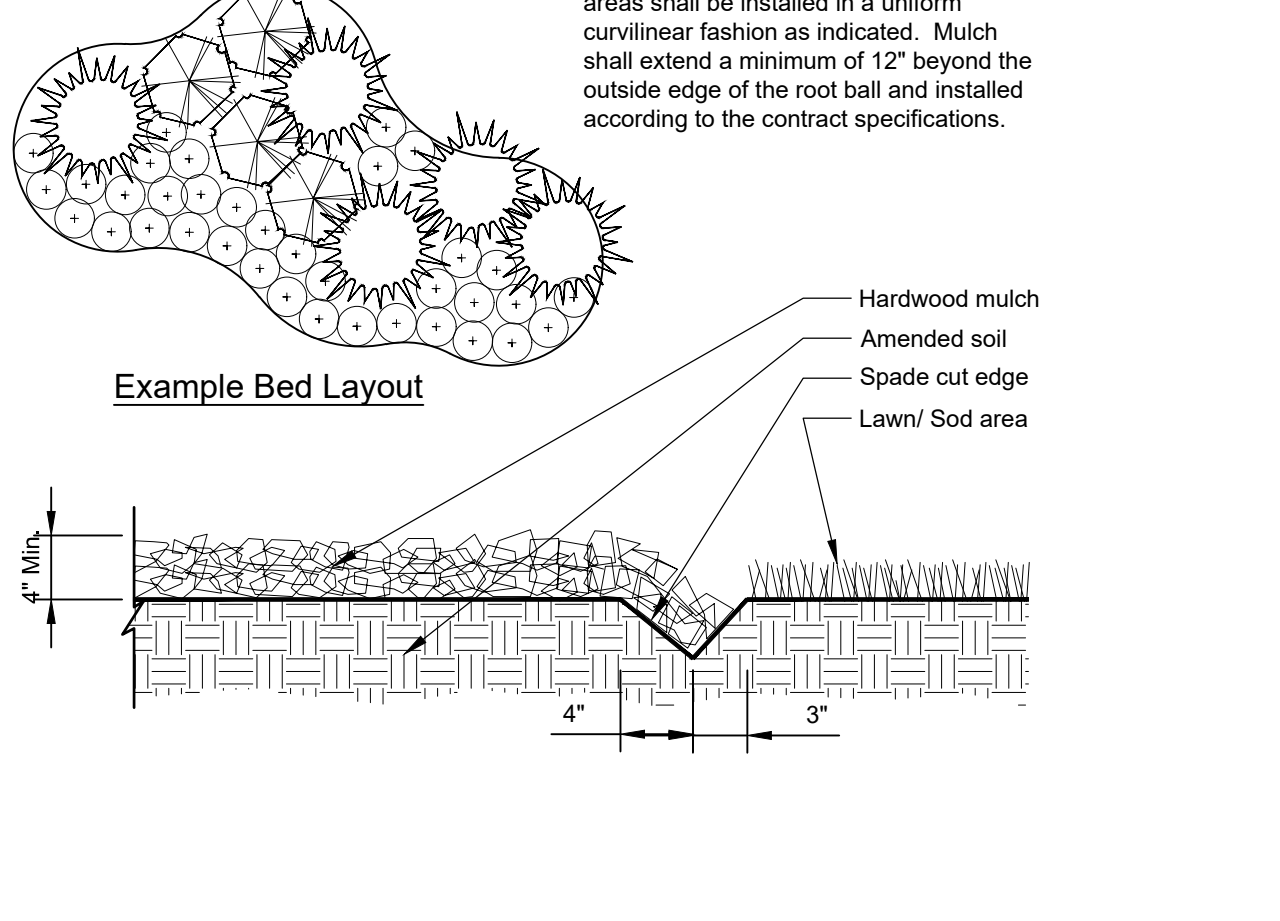


4 CONTINUOUS MULCH EDGING
 1" = 1'-0" 32 9113.26-01

Landscape Notes:

- Seed/ Sod limit line is approximate. Seed/ Sod to limits of grading and disturbance. Contractor responsible for restoration of any unauthorized disruption outside of designated construction area.
- Contractor responsible for erosion control in all seeded/ sodded areas. Tree mulch rings in turf areas are 5' diameter. Contractor shall provide a mulch ring around all existing trees within the limits of work. Remove all existing grass from area to be mulched and provide a typical spade cut edge. Landscape Fabric shall not be installed under mulch. Root flares shall be at or above grade, per specifications, and all rope/cord shall be removed from the base of tree trunks.
- Bedlines are to be spade cut to a minimum depth of 3". Curved bedlines are to be smooth and not segmented.
- All planting, beds shall receive top dressing of mulch. Landscape fabric shall not be installed under mulch.
- Do not locate plants within 10' of utility structures or within 5' horizontally of underground utility lines unless otherwise shown on plans. Consult with Landscape Architect if these conditions exist.
- For Lump Sum Contracts, plants and other materials are quantified and summarized for the convenience of the Owner and jurisdictional agencies only. Confirm and install sufficient quantities to complete the work as drawn and specified. No additional payments will be made for materials required to complete the work as drawn and specified.
- For Unit Price Contracts, payments will be made based on actual quantities installed as measured in place by the Owner's Representative.
- It is the responsibility of the contractor to locate and provide plant material as specified on this plan. The contractor may submit a request to provide substitutions for the specified plant material under the following conditions:
 - Any substitutions proposed shall be submitted to the project owner's representative within two weeks of the award of contract. Substitutions must meet equivalent design and functional goals of the original materials as determined by the owner's representative. Any changes must have the approval of the owner's representative.
 - The request will be accompanied by at least three notices from plant material suppliers that the plant material specified is not available and will not be available prior to construction.
- Verify site conditions and information on drawings. Promptly report any concealed conditions, mistakes, discrepancies or deviations from the information shown in the Contract Documents. The Owner is not responsible for unauthorized changes or extra work required to correct unreported discrepancies. Commencement of work shall constitute acceptance of conditions and responsibility for corrections.
- A minimum of two working days before performing any digging, call underground service alert for information on the location of natural gas lines, electric cables, telephone cables, etc. The contractor shall be responsible for location and protection of all utilities, and repair of any damage resulting from his work at no additional cost to the owner.
- Contractor shall promptly repair all damages to existing site at no cost to owner.
- Refer to landscape specifications for additional conditions, standards, and notes.

March 21, 2024 - 15:08 Draw Name: P:\OldDominion\01_Preliminary\01_Landscape\Plan.dwg Updated by: Jhendricks

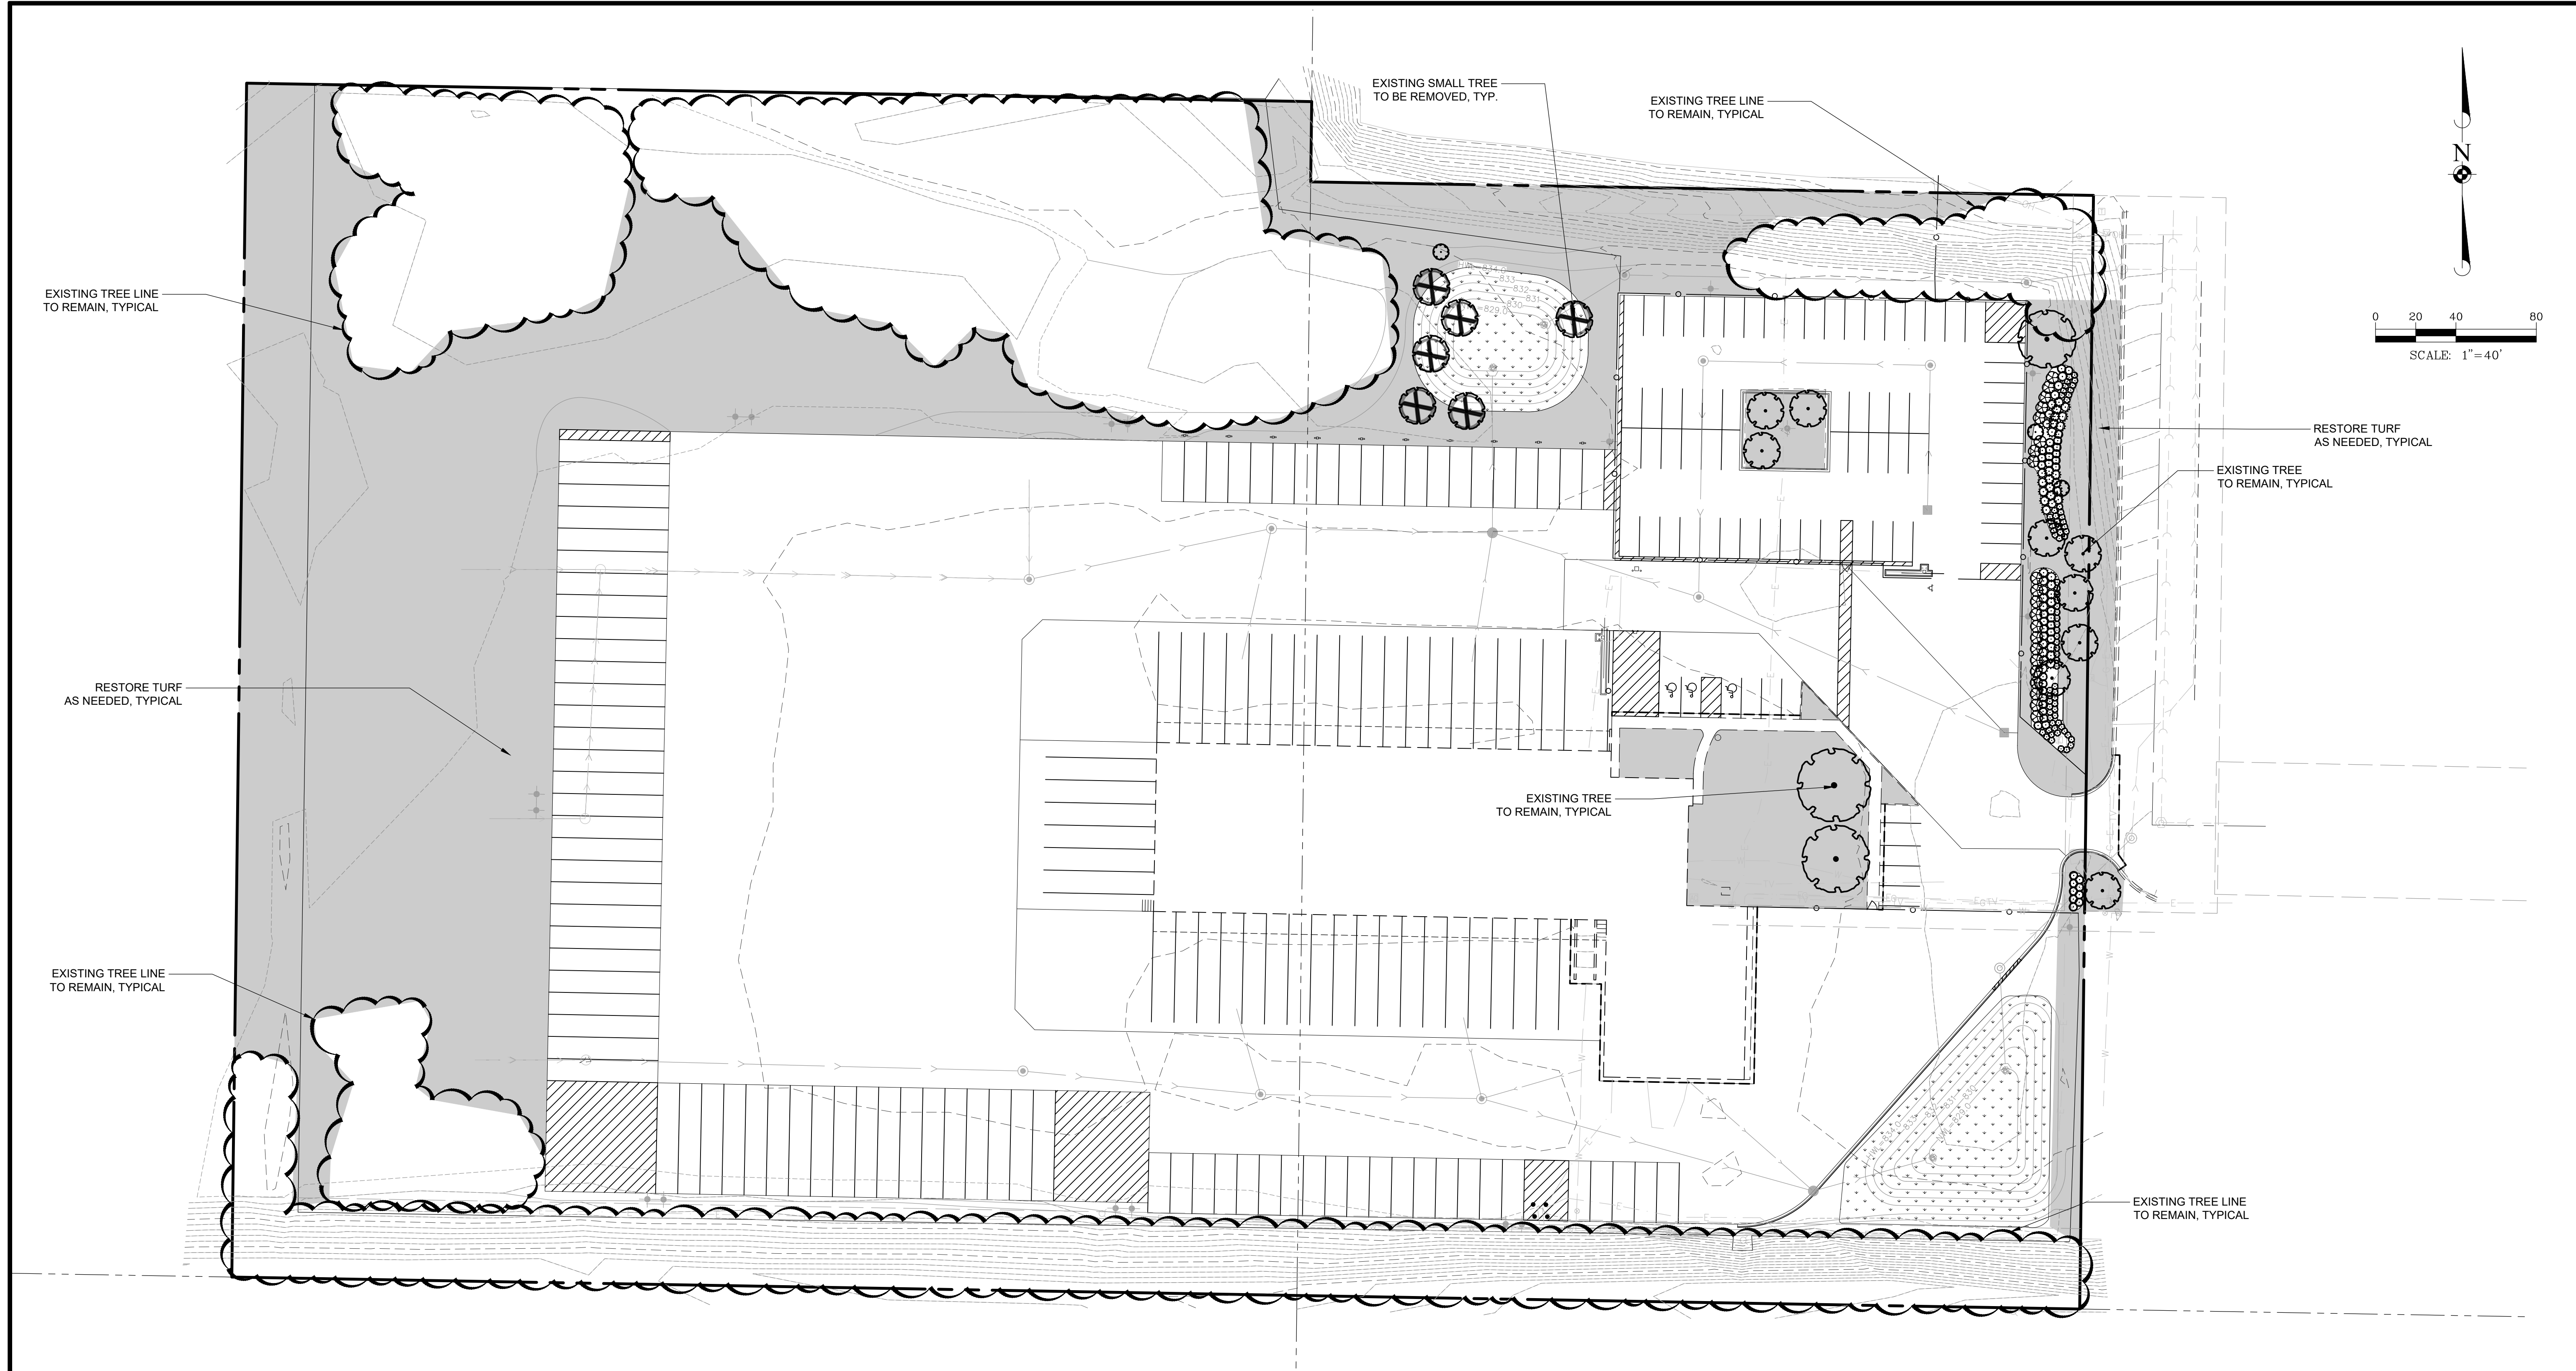

Note: Locations of all existing trees and tree lines and trees are approximate and based on available satellite data. Locations are approximate and field adjustments may be necessary.

CONCEPT PLANT SCHEDULE

| | | |
|--|-------------------------------------------------------------------------------------|-----------|
| | 3' DECIDUOUS SHRUB | 72 |
| | 4' DECIDUOUS SHRUB | 42 |
| | 5' EVERGREEN SHRUB | 44 |
| | 6' DECIDUOUS SHRUB | 21 |
| | STORMWATER SEED MIX LIMITS PRELIMINARY AND SUBJECT TO ADJUSTMENT BEFORE FINAL | 13,687 sf |

| DATE | REVISIONS | DRAWN BY |
|------|-----------|----------|
| | | JSH |

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 www.manhardconsulting.com
 Civil Engineers • Surveyors • Water Resource Engineers • Water & Wastewater Engineers
 Construction Managers • Environmental Scientists • Landscape Architects • Planners

OLD DOMINION FREIGHT LINE KALAMAZOO
 CITY OF KALAMAZOO, MICHIGAN
 PRELIMINARY LANDSCAPE PLAN


PROJ. MGR.: JAR
 PROJ. ASSOC.:
 DRAWN BY: JSH
 DATE: 2/12/2024
 SCALE: AS SHOWN

SHEET
L2 OF **L3**
 ODF.KAMI01

March 22, 2024 - 15:08 Day Name: P:\Odf\kami01\Land\Landplan\01_Preliminary\01_Preliminary\01_Landscape\Plan.dwg Updated by: jshenricks

| Luminaire Schedule | | | | | |
|-----------------------------------------------------------------------------------|-----|------------|-------|-------------|--------------------|
| Symbol | Qty | Lum. Watts | LLF | Arrangement | Description |
|  | 8 | 545.6631 | 0.900 | Twin | RSX4 LED P6 50K R4 |
|  | 5 | 311.92 | 0.900 | Single | RSX3 LED P4 50K R4 |
|  | 4 | 311.92 | 0.900 | Single | RSX3 LED P4 50K R3 |
|  | 1 | 311.92 | 0.900 | Back-Back | RSX3 LED P4 50K R5 |


| Calculation Summary | | | | | | |
|---------------------|-------|------|------|-----|---------|---------|
| Label | Units | Avg | Max | Min | Avg/Min | Max/Min |
| Overall Site | Fc | 2.69 | 13.7 | 0.0 | N.A. | N.A. |
| Employee Lot | Fc | 4.60 | 9.9 | 2.3 | 2.00 | 4.30 |
| Yard | Fc | 4.27 | 13.7 | 1.5 | 2.85 | 9.13 |

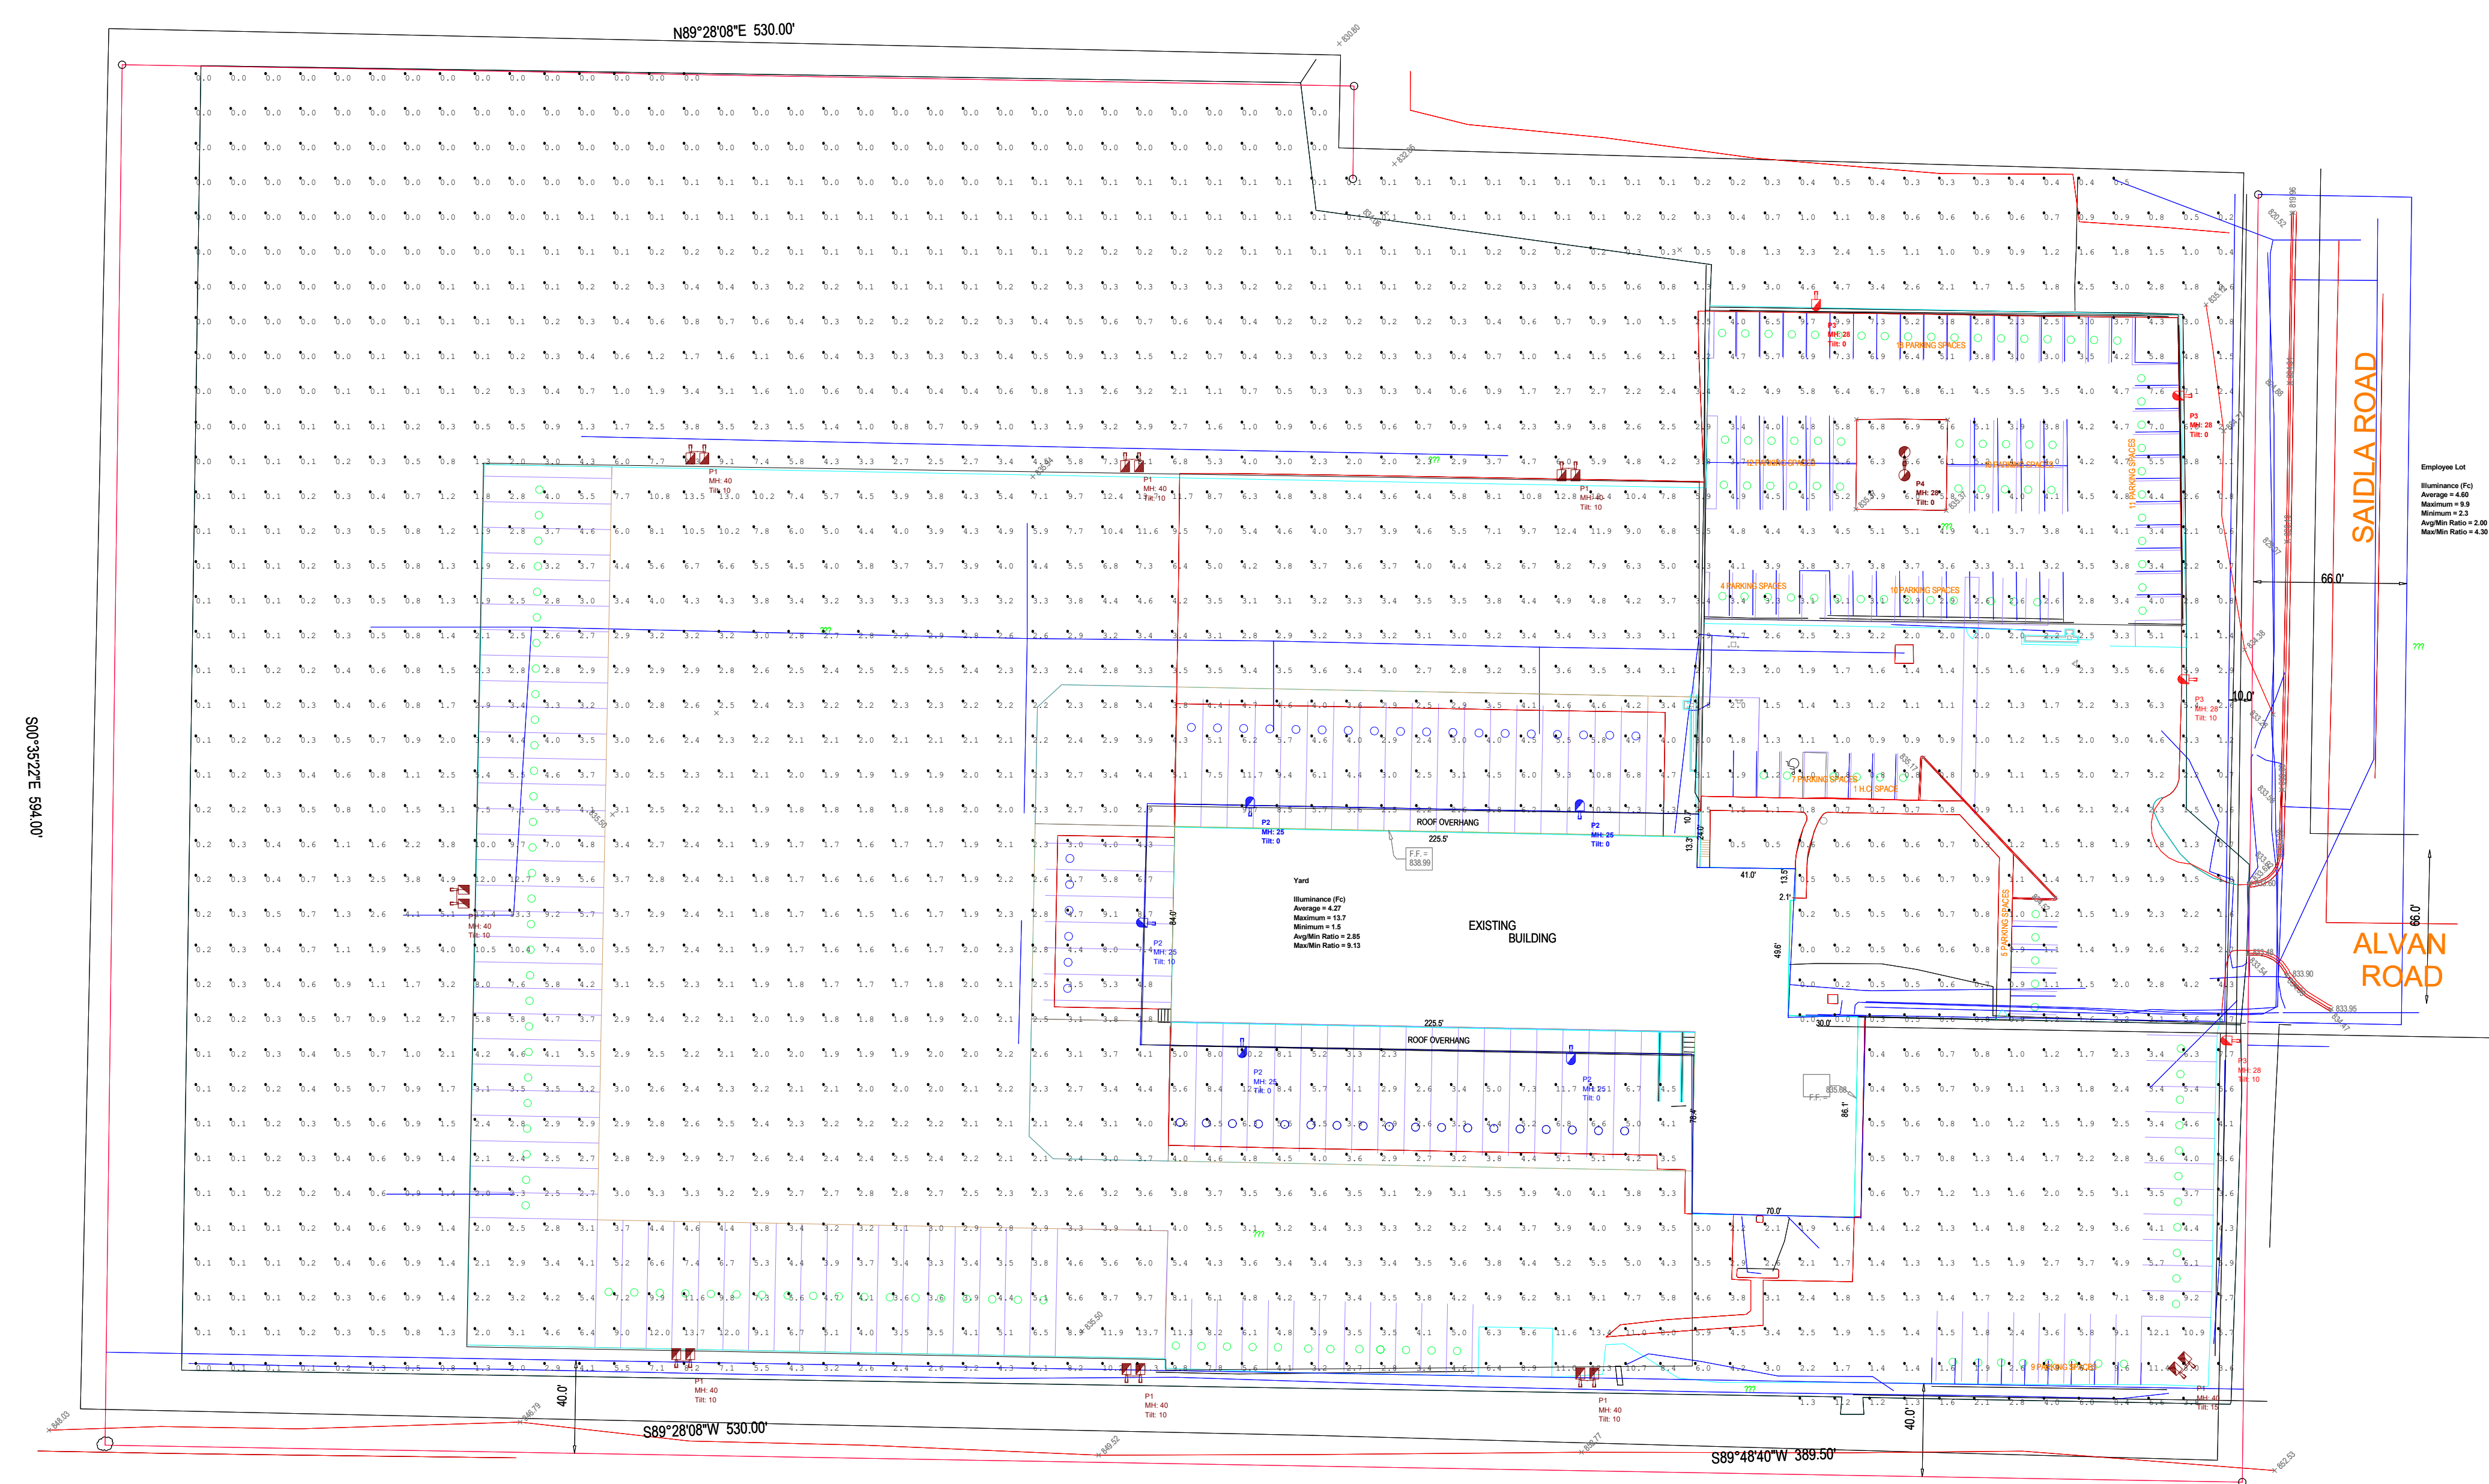

Designed By:
 Date: 12/21/2023
 Scale:


ODFL Kalamazoo

March 21, 2024 - 10:06 Draw Name: P:\048kam01\ken\Final_Dominion_Facilities_Env_Visitiv_Map.dwg Updated By: Charmon

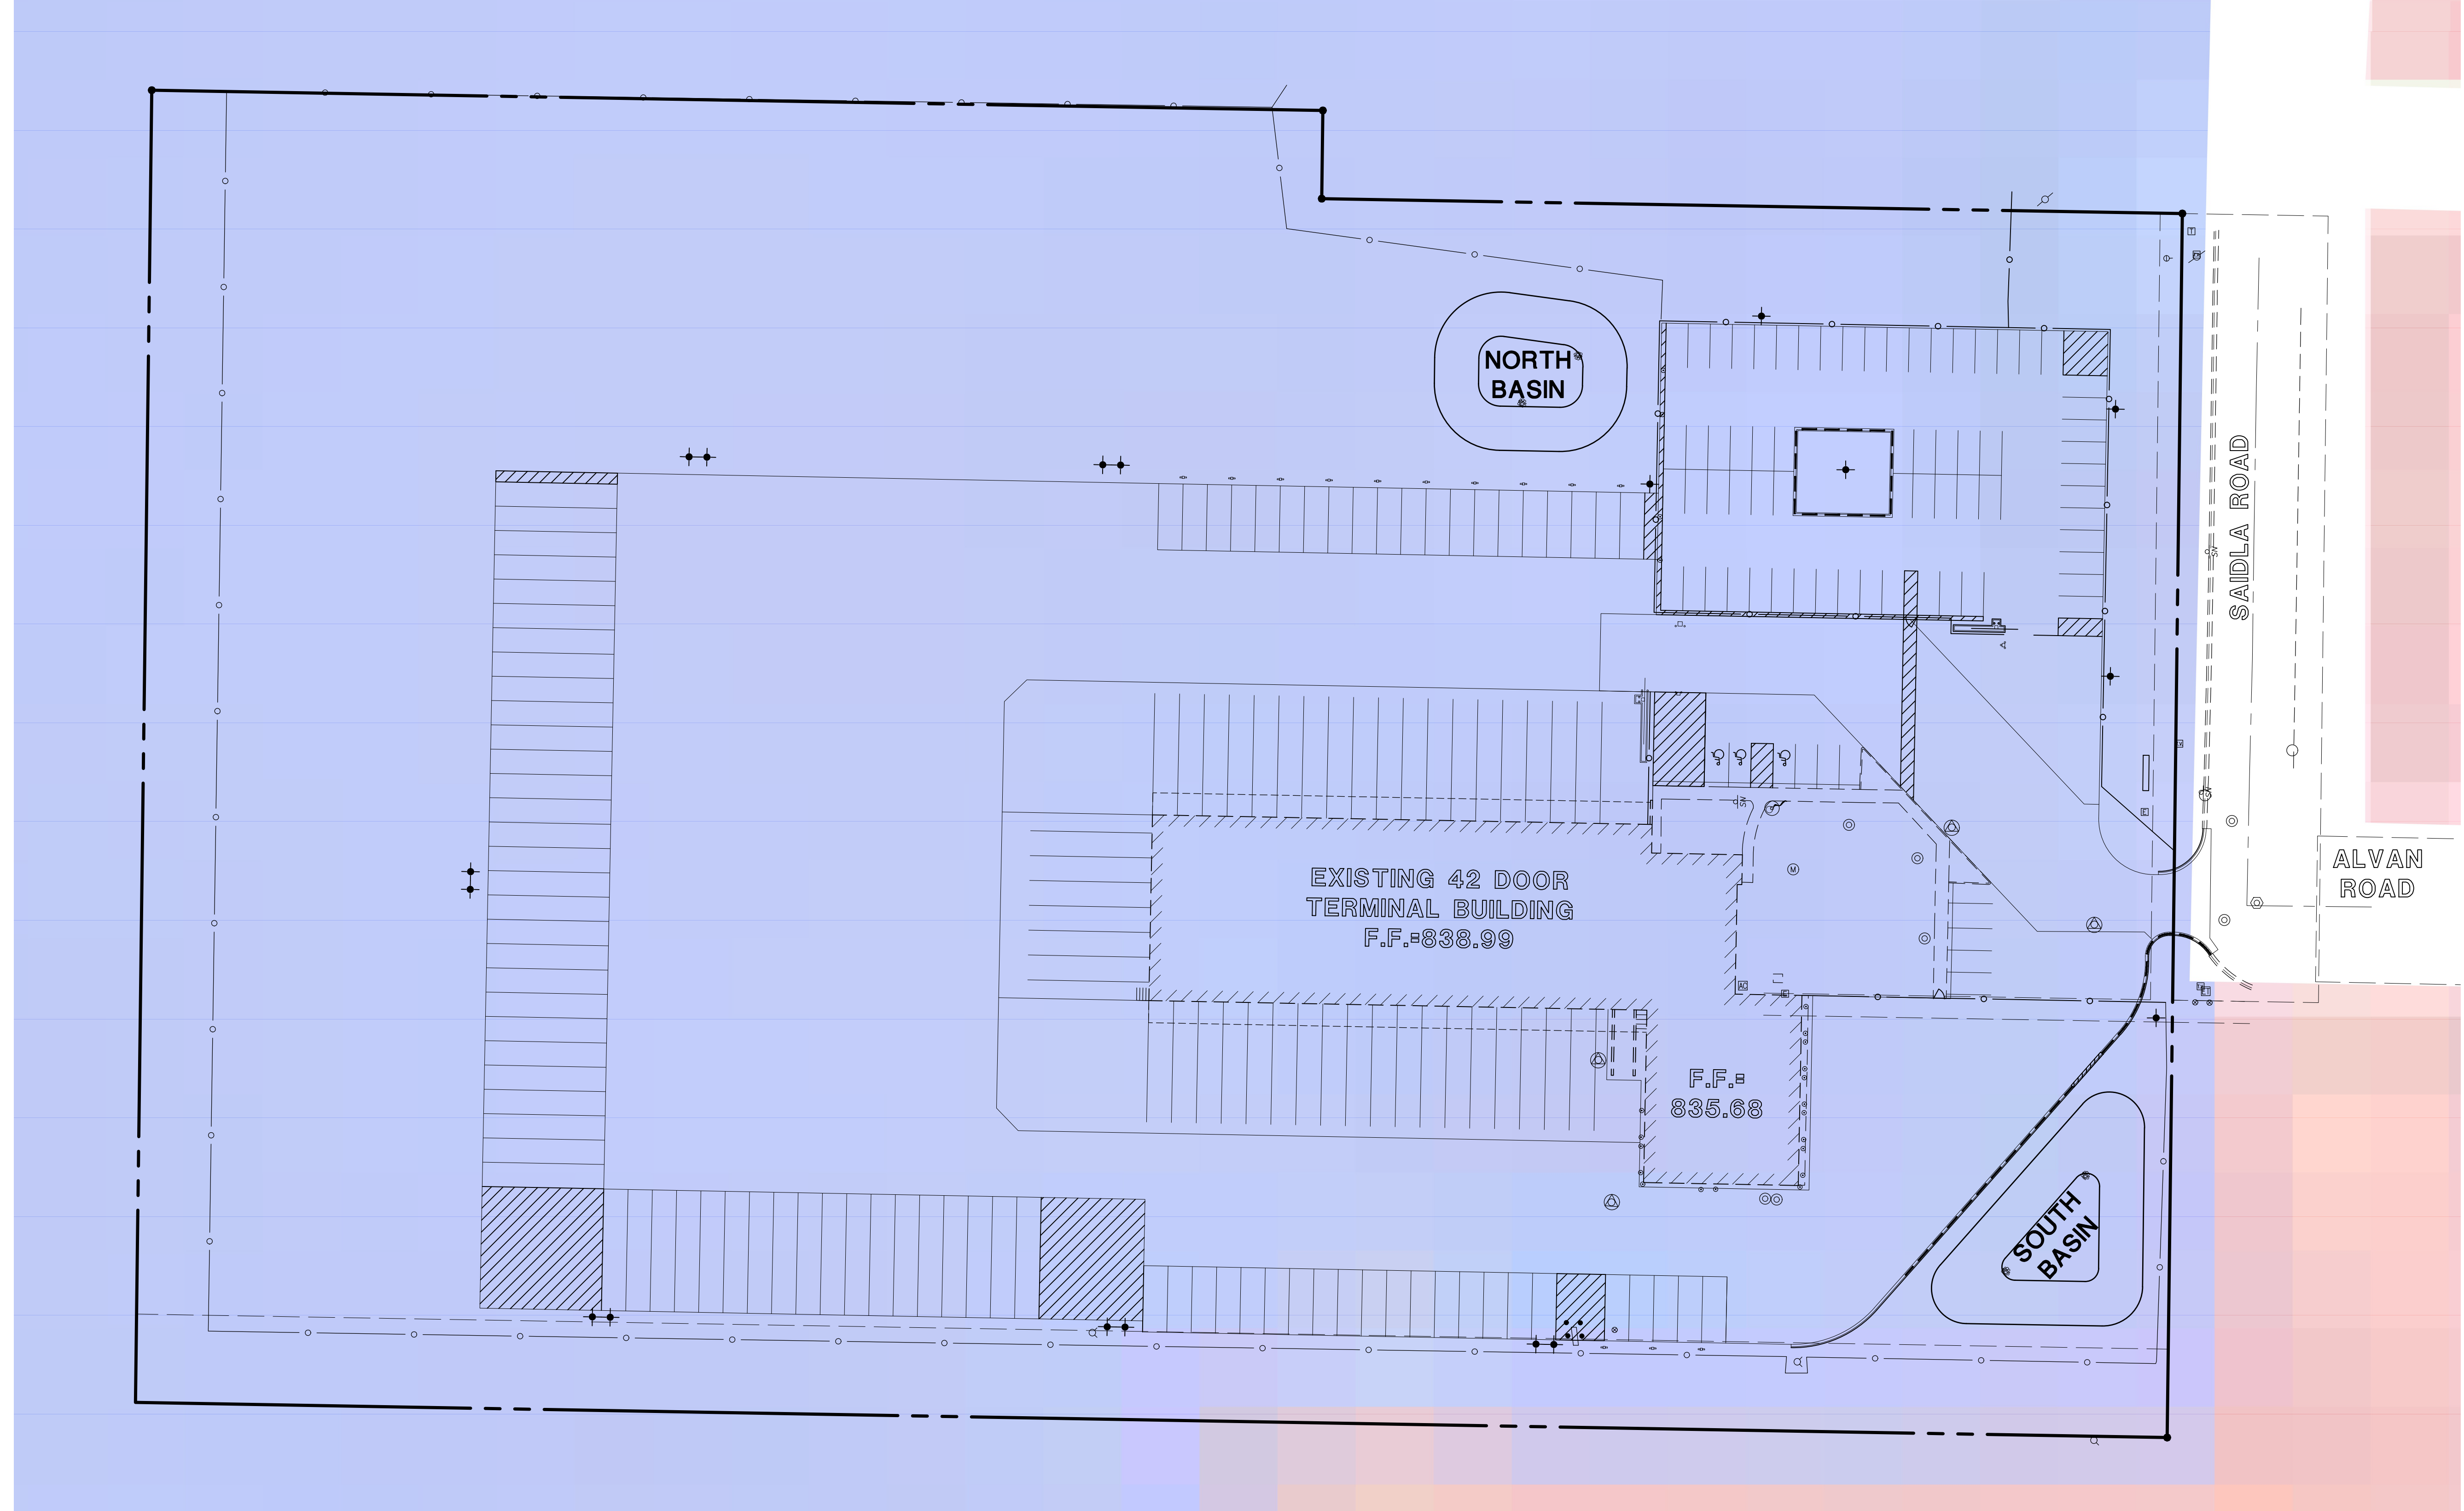

2025 MASTER PLAN LAND DEVELOPMENT

| | |
|------------|---------------|
| INDUSTRIAL | (Blue square) |
| COMMERCIAL | (Red square) |

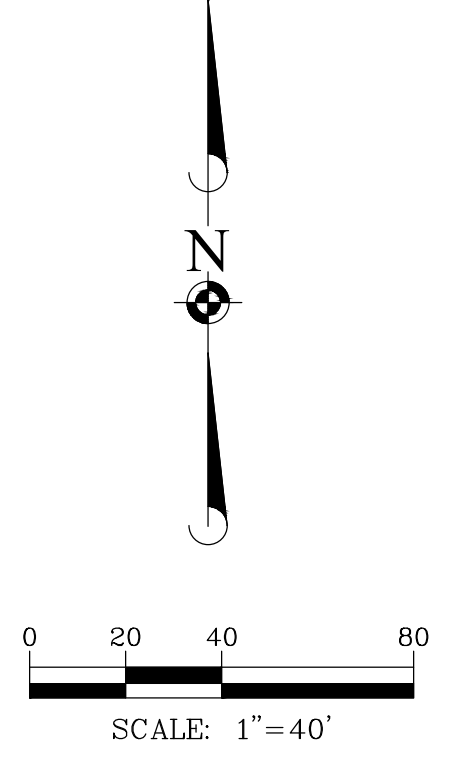

| | |
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| DATE | |
| REVISIONS | |
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Professional Engineers • Surveyors • Wetland Resource Engineers • Water & Wastewater Engineers • Civil Engineers • Environmental Scientists • Environmental Scientists • Landscape Architects • Planners • Construction Managers • Environmental Scientists • Landscape Architects • Planners

VICINITY MAP

OLD DOMINION FREIGHT LINE - KALAMAZOO
CITY OF KALAMAZOO, MICHIGAN

PROJ. MGR.: JAR
PROJ. ASSOC.: MTM
DRAWN BY: CLH
DATE: 03/21/2024
SCALE: 1" = 40'

SHEET
1 of 1
ODF.KAMI.01

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